	ΡΔ\	/ ITEM 201	01000	
	FAI	I I EIVI ZU I	FENCING	
STATION		OFFSET	LN FT	SIDE
JIMION	1001	90.24	73	
	1001	64.8	69	
	1002		69	
	1003	65.46	69	<u></u>
				
	1004	17.07	69	
	1004	61.66	69	
	1004	68.53	68	
	1004	68.76	71	
	1004	93.48	86	
	1005	99.25	66	
	1006		68	
	1006	51.73	66	
	1007		69	
	1007	13.51	68	L
	1007		69	L
	1007		73	
	1007	74.44	65	N
	1008	63.38	67	N
	1009	14.61	67	N
	1010	14.55	68	N
	1010	33.15	59	S
	1011	12.83	74	N
	1012	56.19	68	S
	1014	33.68	67	<u> </u>
	1015	L	68	<u> </u>
	1016		56	<u> </u>
,	1017	<u> </u>	56	<u> </u>
,,,,,,,,,,,,,,,,,,,,,,,,,,,,,,,,,,,,,,	1018		66	<u> </u>
	1018		67	I
	1018	1	68	<u> </u>
	1019	32.16	67	<u> </u>
	1019	ł	69	<u> </u>
				1
	1020		66	1
	1021	18.84	67	<u> </u>
·	1022	33.65	61	<u> </u>
	1022	76.53	69	
	1023	I	68	<u> </u>
	1023		68	<u> </u>
	1024	40.92	72	I
w	1024	48.58	69	L
	1025	29.97	69	<u> </u>
	1025	75.55	69	<u>i</u>
	1026		69	<u> </u>
	1026	1	69	
	1027	39.27	70	
	1027	48.57	69	S
	1027	68.57	119	S
	1027	81.27	N/A	<u> </u>
····	1027	1	N/A	L
	1027		156	<u> </u>
	1027	1	N/A	<u> </u>
	1027	1	N/A	
	1030	1	150	
	1030	1	58	<u> </u>
	1030	1	N/A	<u> </u>
		<u> </u>	<u></u>	L
······································	1030		N/A	
	1030	1	67 2670	<u> </u>
	10	TAL LN FT	3679	LN F

GR K0 SS K0 TOTAL PEREN PERENNIAL PL LS K0	0012990 0012990 0012990 NNIALS - K0012990			529 424 725	529 424 725	Calaminth Geranium	'Rozanne'		F	Lesser Cal Rozanne C	eranium		pot pot	#1 #1	18" o.c. 18" o.c.
SS KO TOTAL PEREN PERENNIAL PL LS KO	0012990					 	 	·····		Rozanne C			pot		
PERENNIAL PL	· · · · · · · · · · · · · · · · · · ·			725	725	Catalan alas		~~~~~~~~~~~~~~~~~~~~~~~~~~~~~~~~~~~~~	~~~~~~~~~~~~~~~~~~~~~~~~~~~~~~~~~~~~~~						
PERENNIAL PL	NNIALS - K0012990				123	Schizachy	rium scoparium		Įt.	Little Blues	stem		pot	#1	18" o.c.
LS K0			Alegacie de la constante de la		1949	EACH	······································	· · · · · · · · · · · · · · · · · · ·	Triple is any		4., 	· · · · · · · · · · · · · · · · · · ·			
LS K0		aal mooneen Laamsen aansparrennen oorsparren op in spositren prononnen sparrangen aandere verbande aan ook in Sont pro		rom grande reported a constitue a menantra in a consideration of the section as administration of the menantra	19.49	UNIT	бот в пределения в поставления в пределения в пределения в пределения в пределения в пределения в пределения в	acronomos de resigue en operación no constituid serve recente de consensações a singuina condituida serve condituida en condituida de consensações que que condituida en c		onnem me à bronnel referen majorines rong nom nonconse, altre margine, pares		s vanden, дубощци жіле 4 и и обилобод (убудоба 8 ишт. шиболошті 10 диболі шива <i>9 ин</i> 7	antinas de san francisco de la comunicipación de genera dos enconocios de como distribución de la comunicación		
LS K0		managaming di ganapatah (inga bangaming pamagaman kan Jugaman akin padahatan Samagan di sahamin), yana akin kan sambah kan padahatan di sahami sambah kan		that we see to the triple on the triple of triple of the triple of triple of the triple of triple	gyppitelesinet peage mitteles (I degly, they found off per land () a al, major mentments, we	encence algorium exemplea encentrate encentr	manifaci e firmina de france e france populações de franço de fran	$w_{i}^{-1}(3d_{i}\phi_{i},k_{i})_{i}w_{i}^{-1}(a_{i}\phi_{i},k_{i})_{i}w_{i}^{-1}(a_{i}\phi_{i}\phi_{i})_{i}w_{i}^{-1}(a_{i}\phi_{i},k_{i})$		Vultarity papers mentindistantilityty polumensustymetin negotomizmit.	oodstationsenensen optivity on the retires beautiful conversion and to see it for distribution conversion and the seed to be a first or the seed of th	Afficience or one of the formation for all and Afficience in account free Astronomy, and a			
LS K0	LANTS PRAIRIE TYP	PE 2" DIAMETER R	Y 4" DEEP	PILIG	ris alla genera langoi la lisanessa manamana manasa da la la la manimanan e y sessi la finada pelphi a		در در داده در این در	$partition \ \ \ \ \ \ \ \ \ \ \ \ \ \ \ \ \ \ \$	Charles and a second	o de la companya de l	,	e vit an effective deus entwere a festiment des en entwere entwette filter transmer d'e « vit santas defermen			
	0013000	1 2 277111 1 2 1 2 1 2 2	1870	3276	5146	Liriope s	nicata		 	Lilyturf			2"	plug	8" o.c.
	NNIALS - K0013000	1	10/0	1 22/0 1	5146	EACH	Joaca			Lity Coll				Ibiaa	10 0.0.
WIAL PENER		a visit managangan da man manatinan at ha manas transformay dipensia a ratina a matina arte masar in busina a			51.46	UNIT	и « тири» обрат в торотина, по учения торот приня поточности на черот тем, и чето, и чето, и в чето подосности			ernern vollaliseleferação anti-e congruenca volta o q	Necessary (where parts are supported by Labeled parts are supported as well as the support of	er vincentia es verme a sul manne es venendo es entre nota estado en entre en escapación es		$m_{\rm total} = 1000 \times $	
		A to good fact a some of a bid for a fact me as to be to summing a soft had proper some or the content of summer.	***************************************		V1.4U	UILI.	a goldening di ser Spillellening di seri sebis se de skipini (a meningan a mede al-lei de de le Norman lande al-lei deskip gell gibi. V m. 1980/1884/ de dellei () ()	Consequence Transform No. 15, and 50 of the final material value of the material value of the design of the final value of the		and the second section of the present of the second and the second second		a destruir and se and mare the mares a speciment post and a section of business business and a		the section of the se	Annual and the second of the second s
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				25200110	201	01400	20101500	20101600	2520	0200	21101615	2110168	5		
				SODDING, SALT	NITE	ROGEN	PHOSPHORUS	POTASSIUM	SUPPLE	MENTAL	TOPSOIL	TOPSOI	_	as at property of the state of	ame of the state o
				TOLERANT	FERT	TLIZER	FERTILIZER	FERTILIZER	WATE	ERING	FURNISH AND	FURNISH A	ND		am, part of the cape
					NUT	RIENT	NUTRIENT	NUTRIENT			PLACE, 4"	PLACE, 2	4"		
$A_{i} \wedge A_{i} = - a_{i} + a_$		and for deplacement a second photocological control for the second and a second control for second control for the		SQ YD	PC	UND	POUND	POUND	UN	TIV	SQ YD	SQ YD			. a servición union riou majoritum con actellipado d
STREET	STATION START	STATION STOP	SIDE							9	-				STAT
	VEEN FRONT OF SI	<u> </u>				والمراجعة المراجعة ا					a articuriones. Colorina con incomina anti ^a destruizaçõe, en 2000 insus est protectura, é y amaçõe, protectura (que de prima parque estruitaçõe) que en coloridad (que en coloridad		name primary namenana a grandony la name pui	WORK B	ETWEEN F
GREEN	1001+95.55	1003+8.27	IN TOTAL	250	1	3.10	3.10	3.10	1	2.50	250		····	GREEN	1002+
	<u></u>		N	213				2.64	.I	2.13	213			GREEN	1004+
GREEN	1003+17.89	1004+57.13				2.64	2.64		1					GREEN	1011+
GREEN	1005+2.65	1007+93.45	N	262		3.24	3.24	3.24	1	2.62	262			GREEN	1014+
GREEN	1008+36.02	1010+35.10	N	177	_1	2.19	2.19	2.19	1	1.77	177			GREEN	1021+
GREEN	1011+10.73	1011+46.72	N	27		0.34	0.34	0.34	1	0.27	27	***************************************		GREEN	10214
GREEN	1014+37.96	1014+92.39	N	43	3	0.53	0.53	0.53		0.43	43			······································	
GREEN	1015+80.37	1018+85.53	N	269)	3.34	3.34	3.34		2.69	269			GREEN	1004+
GREEN	1019+23.04	1019+54.79	N	28	3	0.35	0.35	0.35		0.28	28			GREEN	1007+
GREEN	1020+73.93	1021+14.04	N	3.		0.39	0.39	0.39		0.31	31	***************************************		GREEN	1016+
GREEN	1022+62.91	1024+61.04	N	168		2.08	2.08	2.08	4.	1.68	168			GREEN	1017+
GREEN	1025+22.16	1026+93.45	N	15		1.88	1.88	1.88		1.51	151	<u></u>		GREEN	1020+
GREEN	1027+28.48	1020+84.38	N	46		0.56	0.56	0.56	1	0.46	46			GREEN	1023+
					 				4					GREEN	1024+
GREEN	1029+83.76	1030+86.29	<u>N</u>	6		0.75	0.75	0.75	1	0.61	61			WORK B	ETWEEN B
GREEN	1031+6.27	1031+16.95	N	}	3	0.10	0.10	0.10		0.08	8			GREEN	Good
GREEN	1002+41.02	1004+59.32	S	243		3.01	3.01	3.01		2.43	243			GREEN	Wrigh
GREEN	1006+0.49	1007+80.14	S	92		1.14	1.14	1.14		0.92	92			GREEN	Good
GREEN	1007+86.49	1008+18.66	S	57		0.71	0.71	0.71		0.57	57			<u> </u>	- 0000
GREEN	1008+60.15	1010+35.96	S	311	1	3.85	3.85	3.85		3.11	311			$Q^{1}(M^{2}(x), x)^{2}(A^{2}(x) + M^{2}(x) + M^{2}(x) + M^{2}(x)^{2} + M^{2}(x)^{2}(x) + M^{2}(x)^{2} + M^{2}$	$A = \max\{a_{ij} \in A^{(a_{ij})} : i \in A^{(a_{ij})} \text{ and } i \in A^{(a_{i$
GREEN	1011+11.85	1014+93.14	S	341	1	4.23	4.23	4.23		3.41	341				
GREEN	1015+81.49	1016+63.58	S	65	5	0.81	0.81	0.81		0.65	65				
GREEN	1018+12.46	1018+37.25	S	17	7	0.22	0.22	0.22	***************************************	0.17	17				
GREEN	1018+75.24	1019+48.40	s	65	5	0.80	0.80	0.80		0.65	65				
GREEN	1019+94.39	1020+53.87	s	50		0.66	0.66	0.66	1	0.53	53				
GREEN	1020+65.87	1023+54.32	s	252	. 1	3.12	3.12	3.12	<u> </u>	2.52	252				
GREEN	1024+94.13	1025+14.17	S	15		0.12	0.19	0.19		0.15	15				
GREEN	1025+23.17	1023+14.17	S	23		2.86	2.86	2.86		2.31	231				
			_ I							<u></u>	.,				
GREEN	1030+92+42	1031+24.64	S	10		0.16	0.16	0.16		0.13	13				
MATTHEWS	1100+63.99	1101+1.33	W	28		0.35	0.35	0.35		0.28	28				
MATTHEWS	1100+63.99	1100+96.44	E	2.		0.27	0.27	0.27		0.21	21				
GOODWIN	1201+35.31	1201+54.08	W	14	<u> </u>	0.18	0.18	0.18	<u> </u>	0.14	14				
GREGORY	1250+44.1	1250+61.00	W	2	1	0.26	0.26	0.26		0.21	21				
			Subtota	3575	5	44	44	44		36	3575		0		
	ki ku mijikanga na si magan yangan sadang panamana maka tamang nananan mijigi mapini dan panawini pal B							massen og kremsel profesion og en sen om kom med held stad formeld ha <u>ren og en et et er florme</u> d en deg en elsem			ну (т. н. контрольной урганий на промещения к _с удника подобрену у тостиную досум досум поднесной от подобрение п С	operantiples, construire arminopoly, company and polytopoly and company for an end are commented are commented	And the second s		
WORK BETW	VEEN BACK OF SID	EWALK - CONST	RUCTION	LIMIT	<u></u>	······································			*		· · · · · · · · · · · · · · · · · · ·	· · · · · · · · · · · · · · · · · · ·			
GREEN	Wright	Matthews	N	373	3	4.63	4.63	4.63		3.73	202		172		
GREEN	Matthews	Goodwin	N	553		6.85	6.85	6.85		5.53	437		116		
GREEN	Goodwin		N	190		2.35	2.35	2.35	1	1.90	151		35		
		Gregory	N	<u> </u>					1						
GREEN	Gregory	Lincoln	11.4	139		1.72		1.72		1.39	100		245		
GREEN	Wright	Matthews	S	1260	<u>l </u>	15.61	15.61	15.61		12.60	1015		245		
GREEN	Matthews	Goodwin	S	34		0.43		0.43	<u> </u>	0.34					
GREEN	Goodwin	Lincoln	S	833		10.33		10.33	,,,,,,,,,,,,,,,,,,,,,,,,,,,,,,,,,,,,,	8.33			97		
1			Subtota			42	42	42		34			665		
L		5	TOTAL	695		86	86	86	,	70	6289		665		

LANDSCAPE SCHEDULE

Acer saccharum 'Bailsta'

3 Acer saccharum 'Green Mountain'

Celtis occidentalis

Querus bicolor

Ulmus 'Frontier'

Tilia tomentosa

Carpinus betulus

137 Hydrangea arborescens

236 Spiraea x cinerea 'Grefsheim'

6 Cercis canadensis

5

4

13 EACH

373 EACH

271 **271** Amsonia hubrichtii

COMMON NAME

Fall Fiesta Sugar Maple

Green Mountain Sugar Maple

Common Hackberry

Swamp White Oak

Eastern Redbud

Frontier Elm

Silver Linden

Common Hornbeam

Smooth Hydrangea

Threadleaf Bluestar

Grefsheim Spirea

SIZE

2.5" cal

3"-4" cal

3"-4" cal

8' ht

8' ht

3"-4" cal B&B

3"-4" cal B&B

3"-4" cal B&B

ROOT REMARKS

B&B matching heads

B&B matching heads

36" o.c. per plan

36" o.c. per plan

24" o.c.

B&B

B&B

B&B

pot

LAND LAND LAND LAND UNION TOTAL

5

13

PLN 1 PLN 2 PLN 3 PLN 4 PLN 5 PLAN QUANTITY BOTANICAL NAME

2

4

223

CODE

CO QB

SHRUBS

PAY ITEM A2001722

A2002924

A2006524

B2001167

XX006570

XX006570

XX006570

XX006570

XX008639

XX008639

TOTAL SHRUBS - XX008639

PERENNIALS, GALLON POT

K0012990

TOTAL TREES (SPECIAL) - XX006570

TREES (SPECIAL)

3

			and the same of th	K1005481	X0327802
ermonen er er enmannet i Steffelbolt i Addition (ASA), Steffe et til 1942 til 1944 til 1944 til 1944 til 1944	A 2 of that a to a second of the second of t	And the second s	And the second of the second s	SHREDDED BARK	PLANTING SOIL
			NA ANDREAS	MULCH 3"	MIX FURNISH AND
no dennocació à ribrigiliste per sociale e a limb frimmano o e de giue per chemistrale Venice acces e e		and the state of t			PLACE, 12"
	ar antiquama van anggilijakak			SQ YD	SQ YD
	STATION START	STATION STOP	SIDE		
WORK BET	TWEEN FRONT OF SI	DEWALK - BACK	OF CURB		
GREEN	1002+79.27	1003+10.80	N	25.44	25.44
GREEN	1004+78.95	1006+76.51	MEDIAN	212.11	212.11
GREEN	1011+44.10	1011+94.37	N	69.67	69.67
GREEN	1014+18.70	1014+35.11	N	8.67	8.67
GREEN	1021+09.90	1021+63.18	N	66.22	66.22
GREEN	1022+28.73	1022+59.18	N	17.78	17.78
GREEN	1004+95.20	1005+27.63	S	31.33	31.33
GREEN	1007+88.94	1007+97.04	S	3.67	3.67
GREEN	1016+67.33	1016+97.78	S	17.78	17.78
GREEN	1017+63.33	1018+16.61	S	66.22	66.22
GREEN	1020+11.17	1021+16.66	MEDIAN	79.89	79.89
GREEN	1023+58.06	1023+88.51	S	17.78	17.78
GREEN	1024+54.07	1024+96.61	S	50.78	50.78
WORK BET	TWEEN BACK OF SID	EWALK - CONSTI	RUCTION	LIMITS	
GREEN	Goodwin	Gregory	N	9	9
GREEN	Wright	Matthews	S	828	828
GREEN	Goodwin	Lincoln	S	18	18
			TOTAL	1522.44	1522.33

	.,,,,,,,,,,,,,,,,,,,,,,,,,,,,,,,,,,,,		.,,
•	FILE \$FILE	NAME EL\$	=
	PLOT	DATE	=

\$DATE\$ \$TIME\$

DATE	=	MARCH 2016	REVISED	-
CHECKED	-	ВМ	REVISED	•
DRAWN	-	JR	REVISED	-
DESIGNED		BK	REVISED	-

STATE	OF	ILLINOIS
DEPARTMENT	OF	TRANSPORTATION

SCALE:: |"=20"

. AND COADE CONEDURE	RTE.	SEC	TION	COUNTY	SHEETS	SHE
LANDSCAPE SCHEDULE		15-0030)4-0I-PV	CHAMPAIGN	236	127
		MCORE PRO	JECT I	CONTRACT	NO.915	39
NO. 127 OF 236 SHEETS STA. TO STA.	JOB N	IO C-95-305-IS	ILLINOIS FED.	AID PROJECT TIG-	5:8(O57)	

STATE OF ILLINOIS

DEPARTMENT OF TRANSPORTATION

SECTION

15-00304-0I-PV

JOB NO. C-95-305-16 | ILLINOIS | FED. AID PROJECT TIG-5181(057)

MCORE PROJECT I

TO STA. 1006+00.00

CHAMPAIGN 236 128

CONTRACT NO.91539

LANDSCAPE PLAN - GREEN STREET

SHEET NO. 128 OF 236 SHEETS | STA.

SCALE:: 1"=20'

REVISED

REVISED

REVISED

REVISED

DESIGNED

DRAWN

DATE

CHECKED

FILE NAME =

PLOT DATE =

P1-sht-GRNE-land01.dgn


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BK

ВМ

MARCH 2016

- JR

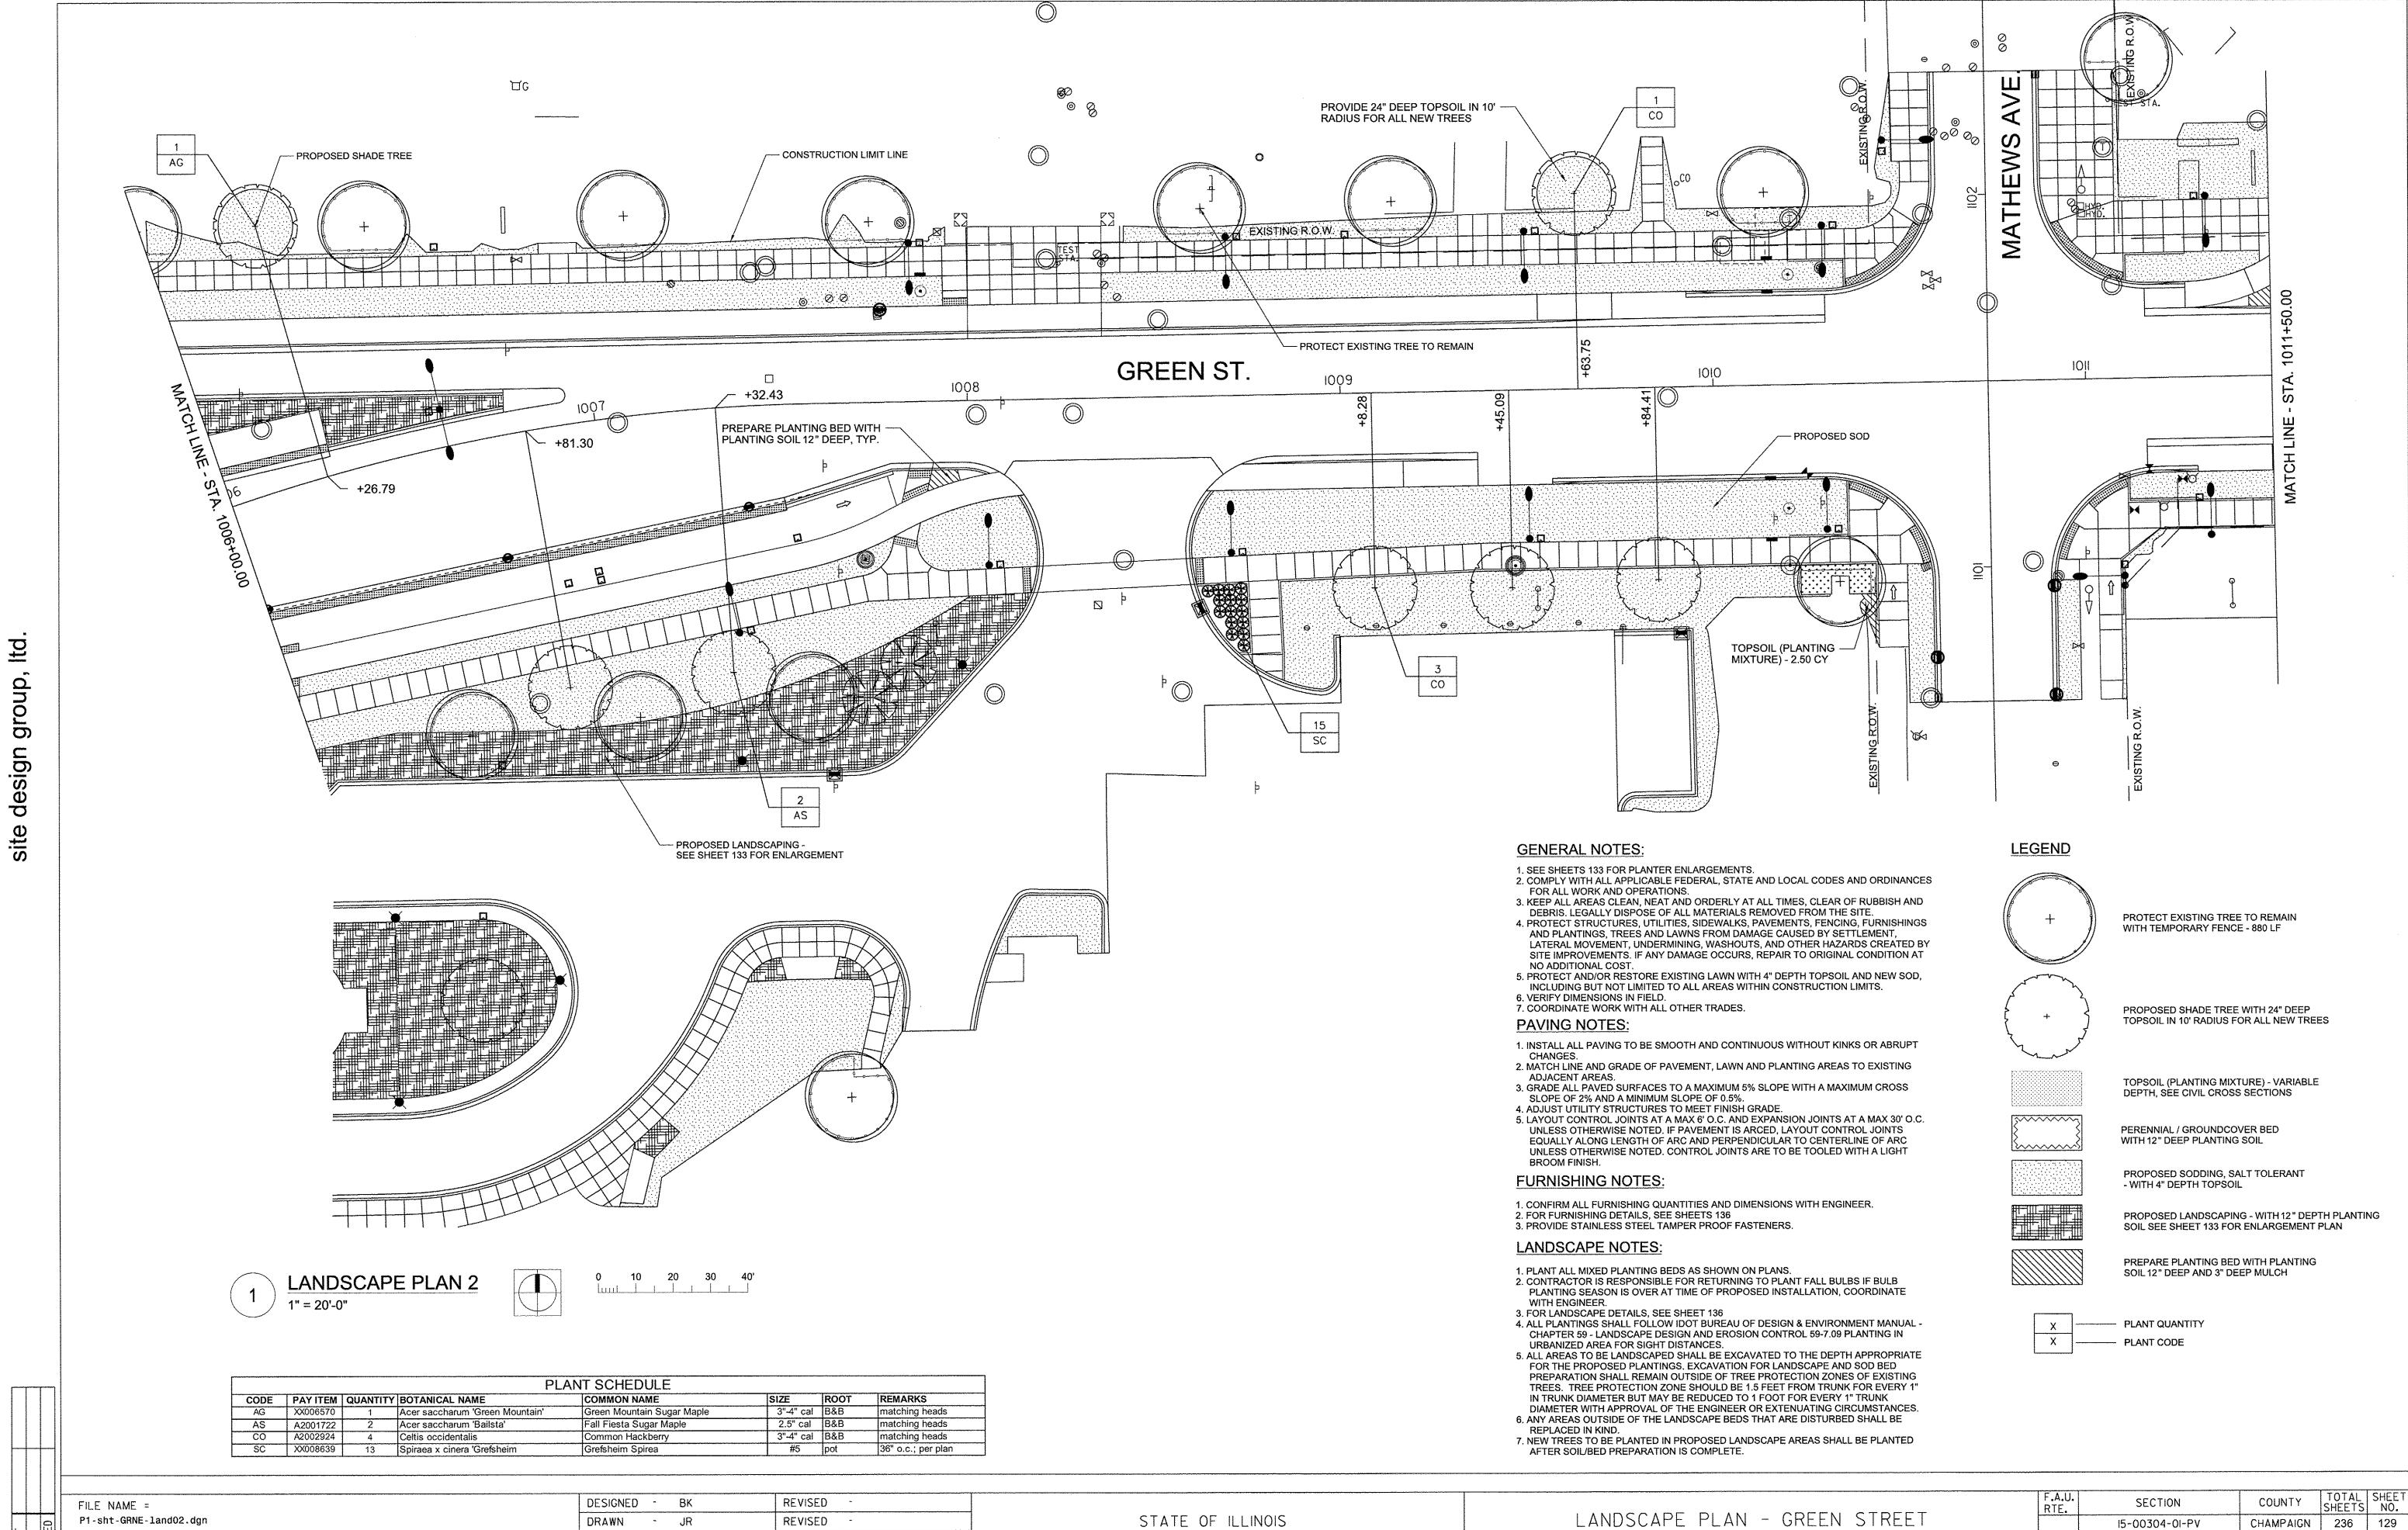

DEPARTMENT OF TRANSPORTATION

MCORE PROJECT I

JOB NO. C-95-305-16 | ILLINOIS | FED. AID PROJECT TIG-5181(057)

SHEET NO. 129 OF 236 SHEETS | STA. 1006+00.00 TO STA. 1011+50.00

SCALE:: 1"=20'

CONTRACT NO.91539

REVISED

REVISED

CHECKED


DATE

BM

MARCH 2016

PLOT DATE =

3/23/2016 11:42:07 AM

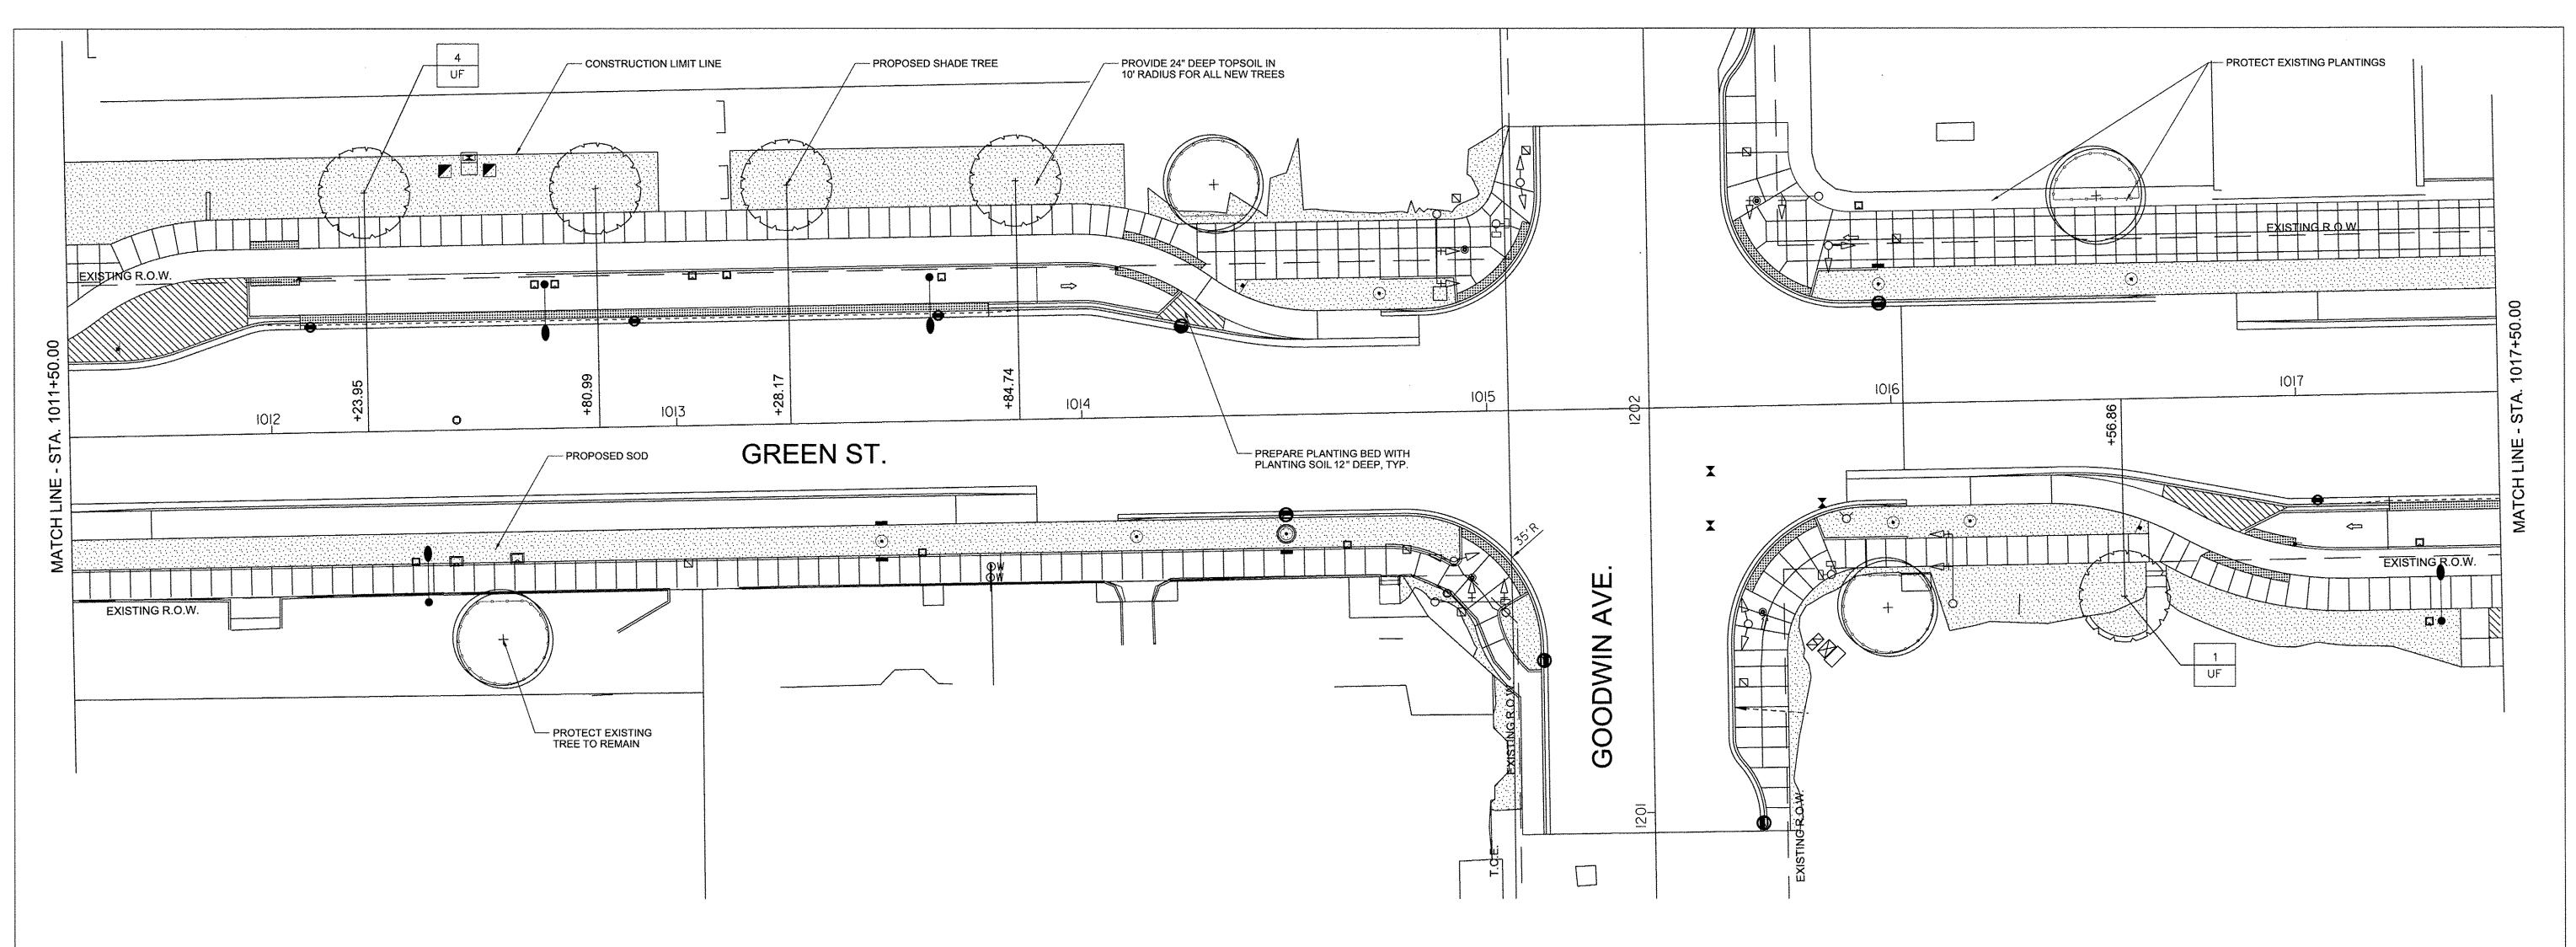

GENERAL NOTES:

- 1. SEE SHEETS 133 FOR PLANTER ENLARGEMENTS. 2. COMPLY WITH ALL APPLICABLE FEDERAL, STATE AND LOCAL CODES AND ORDINANCES
- FOR ALL WORK AND OPERATIONS. 3. KEEP ALL AREAS CLEAN, NEAT AND ORDERLY AT ALL TIMES, CLEAR OF RUBBISH AND
- DEBRIS. LEGALLY DISPOSE OF ALL MATERIALS REMOVED FROM THE SITE. 4. PROTECT STRUCTURES, UTILITIES, SIDEWALKS, PAVEMENTS, FENCING, FURNISHINGS AND PLANTINGS, TREES AND LAWNS FROM DAMAGE CAUSED BY SETTLEMENT, LATERAL MOVEMENT, UNDERMINING, WASHOUTS, AND OTHER HAZARDS CREATED BY SITE IMPROVEMENTS. IF ANY DAMAGE OCCURS, REPAIR TO ORIGINAL CONDITION AT
- NO ADDITIONAL COST. 5. PROTECT AND/OR RESTORE EXISTING LAWN WITH 4" DEPTH TOPSOIL AND NEW SOD, INCLUDING BUT NOT LIMITED TO ALL AREAS WITHIN CONSTRUCTION LIMITS.
- 6. VERIFY DIMENSIONS IN FIELD. 7. COORDINATE WORK WITH ALL OTHER TRADES.

PAVING NOTES:

- 1. INSTALL ALL PAVING TO BE SMOOTH AND CONTINUOUS WITHOUT KINKS OR ABRUPT
- 2. MATCH LINE AND GRADE OF PAVEMENT, LAWN AND PLANTING AREAS TO EXISTING ADJACENT AREAS.
- 3. GRADE ALL PAVED SURFACES TO A MAXIMUM 5% SLOPE WITH A MAXIMUM CROSS SLOPE OF 2% AND A MINIMUM SLOPE OF 0.5%.
- 4. ADJUST UTILITY STRUCTURES TO MEET FINISH GRADE. 5. LAYOUT CONTROL JOINTS AT A MAX 6' O.C. AND EXPANSION JOINTS AT A MAX 30' O.C. UNLESS OTHERWISE NOTED. IF PAVEMENT IS ARCED, LAYOUT CONTROL JOINTS EQUALLY ALONG LENGTH OF ARC AND PERPENDICULAR TO CENTERLINE OF ARC UNLESS OTHERWISE NOTED. CONTROL JOINTS ARE TO BE TOOLED WITH A LIGHT BROOM FINISH.

FURNISHING NOTES:

1. CONFIRM ALL FURNISHING QUANTITIES AND DIMENSIONS WITH ENGINEER.

2. FOR FURNISHING DETAILS, SEE SHEETS 136 3. PROVIDE STAINLESS STEEL TAMPER PROOF FASTENERS.


LANDSCAPE NOTES:


- 1. PLANT ALL MIXED PLANTING BEDS AS SHOWN ON PLANS.
- 2. CONTRACTOR IS RESPONSIBLE FOR RETURNING TO PLANT FALL BULBS IF BULB PLANTING SEASON IS OVER AT TIME OF PROPOSED INSTALLATION, COORDINATE WITH ENGINEER. 3. FOR LANDSCAPE DETAILS, SEE SHEET 136
- 4, ALL PLANTINGS SHALL FOLLOW IDOT BUREAU OF DESIGN & ENVIRONMENT MANUAL -CHAPTER 59 - LANDSCAPE DESIGN AND EROSION CONTROL 59-7.09 PLANTING IN URBANIZED AREA FOR SIGHT DISTANCES.
- 5. ALL AREAS TO BE LANDSCAPED SHALL BE EXCAVATED TO THE DEPTH APPROPRIATE FOR THE PROPOSED PLANTINGS, EXCAVATION FOR LANDSCAPE AND SOD BED PREPARATION SHALL REMAIN OUTSIDE OF TREE PROTECTION ZONES OF EXISTING TREES. TREE PROTECTION ZONE SHOULD BE 1.5 FEET FROM TRUNK FOR EVERY 1" IN TRUNK DIAMETER BUT MAY BE REDUCED TO 1 FOOT FOR EVERY 1" TRUNK DIAMETER WITH APPROVAL OF THE ENGINEER OR EXTENUATING CIRCUMSTANCES. 6. ANY AREAS OUTSIDE OF THE LANDSCAPE BEDS THAT ARE DISTURBED SHALL BE
- REPLACED IN KIND. 7. NEW TREES TO BE PLANTED IN PROPOSED LANDSCAPE AREAS SHALL BE PLANTED AFTER SOIL/BED PREPARATION IS COMPLETE.

LEGEND





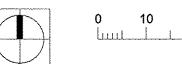

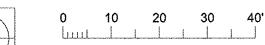

SCALE:: 1"=20'



TOPSOIL (PLANTING MIXTURE) - VARIABLE

PROPOSED SHADE TREE WITH 24" DEEP TOPSOIL IN 10' RADIUS FOR ALL NEW TREES



DEPTH, SEE CIVIL CROSS SECTIONS PERENNIAL / GROUNDCOVER BED

WITH 12" DEEP PLANTING SOIL



PROPOSED SODDING, SALT TOLERANT - WITH 4" DEPTH TOPSOIL




PROPOSED LANDSCAPING - WITH 12" DEPTH PLANTING SOIL SEE SHEET 133 FOR ENLARGEMENT PLAN



PREPARE PLANTING BED WITH PLANTING

SOIL 12" DEEP AND 3" DEEP MULCH

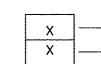

PLANT QUANTITY --- PLANT CODE

PLANT SCHEDULE									
CODE	PAY ITEM	QUANTITY	BOTANICAL NAME	COMM	ON NAME	SIZE	ROOT	REMARKS	······
115	YY006570	T = = = = = = = = = = = = = = = = = = =	I limus 'Erontior'	Eroptier	· Elm	3" 4" cal	R&R	matching heads	

FILE NAME =


P1-sht-GRNE-land03.dgn PLOT DATE =

3/23/2016 11:42:56 AM

DESIGNED	-	ВК	REVISED	*
DRAWN	-	JR	REVISED	
CHECKED	-	ВМ	REVISED	-
DATE	-	MARCH 2016	REVISED	-

STATE OF ILLINOIS DEPARTMENT OF TRANSPORTATION

SECTION COUNTY RTE. LANDSCAPE PLAN - GREEN STREET CHAMPAIGN 236 130 15-00304-01-PV MCORE PROJECT I CONTRACT NO.91539 SHEET NO. 130 OF 236 SHEETS | STA. 1011+50.00 TO STA. 1017+50.00 JOB NO. C-95-305-16 | ILLINOIS | FED. AID PROJECT TIG-5181(057)

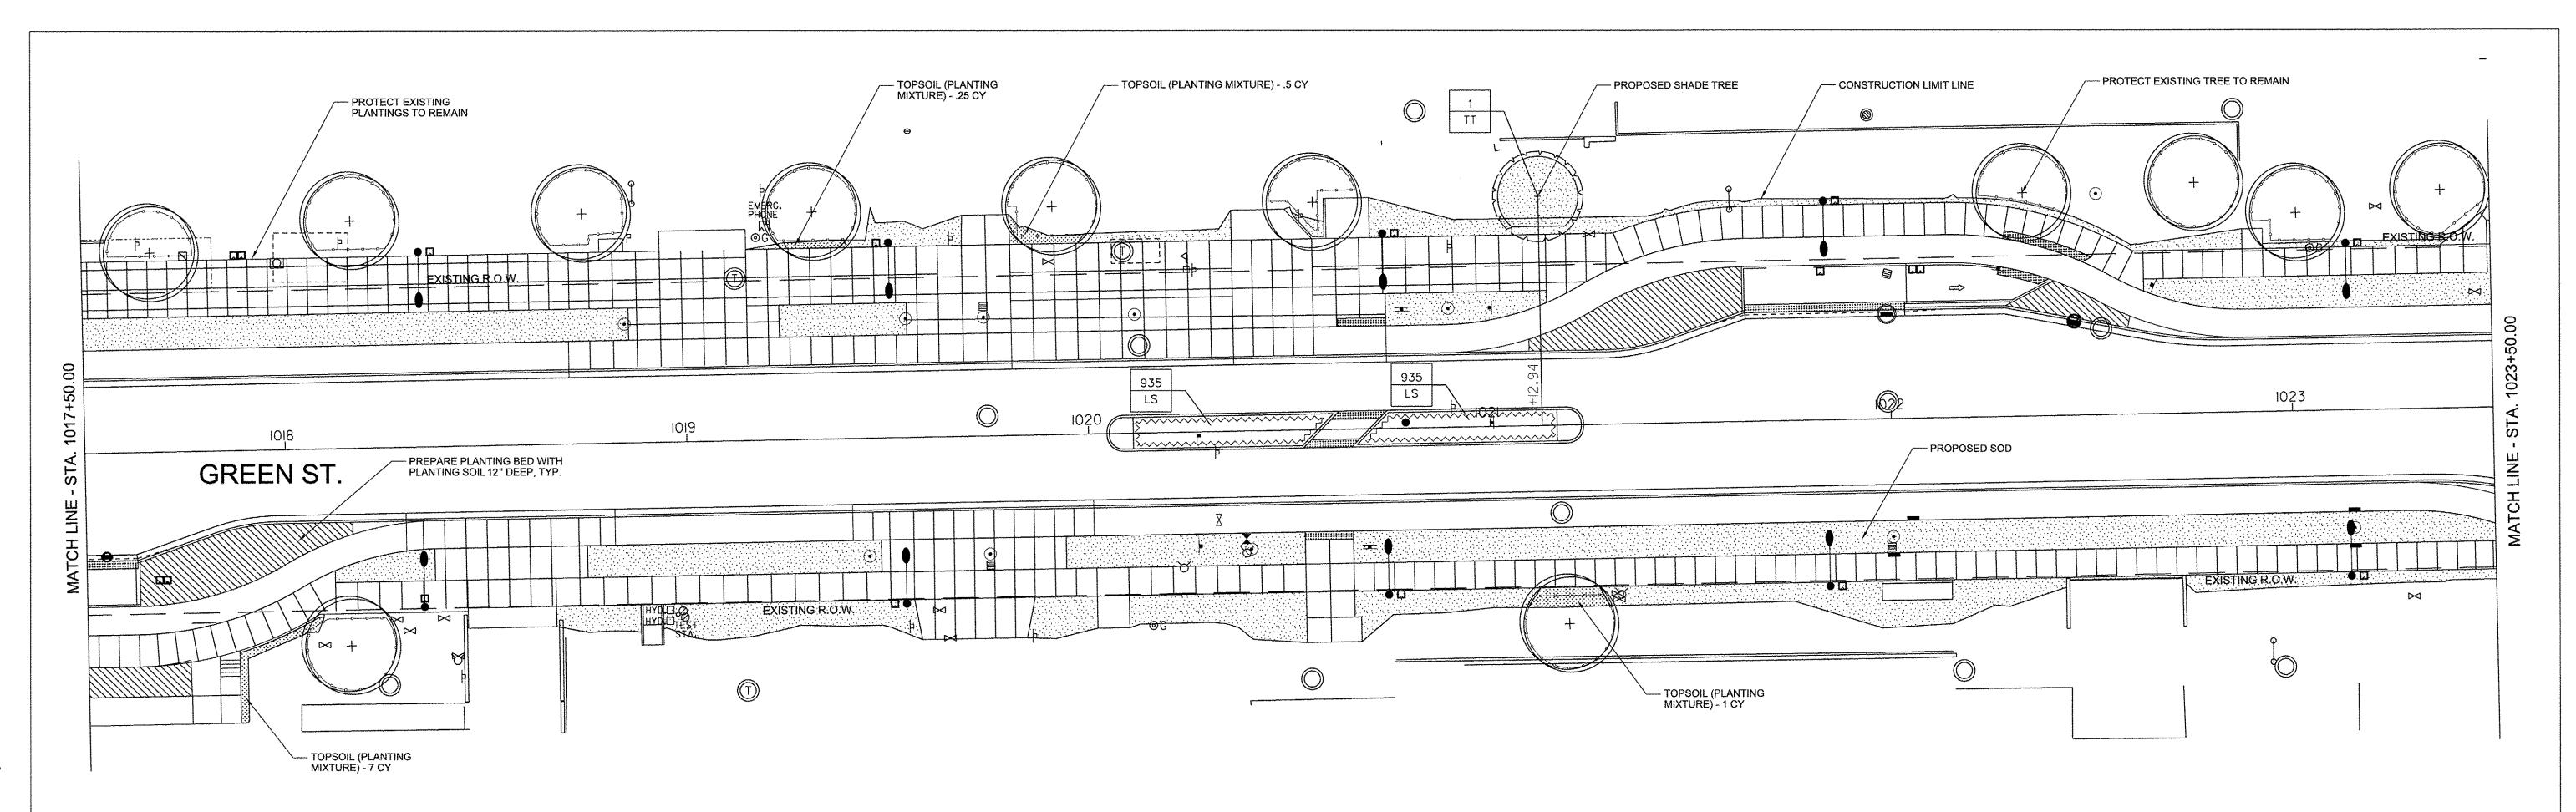

GENERAL NOTES:

- SEE SHEETS 133 FOR PLANTER ENLARGEMENTS. 2. COMPLY WITH ALL APPLICABLE FEDERAL, STATE AND LOCAL CODES AND ORDINANCES FOR ALL WORK AND OPERATIONS.
- 3. KEEP ALL AREAS CLEAN, NEAT AND ORDERLY AT ALL TIMES, CLEAR OF RUBBISH AND DEBRIS. LEGALLY DISPOSE OF ALL MATERIALS REMOVED FROM THE SITE.
- 4. PROTECT STRUCTURES, UTILITIES, SIDEWALKS, PAVEMENTS, FENCING, FURNISHINGS AND PLANTINGS, TREES AND LAWNS FROM DAMAGE CAUSED BY SETTLEMENT, LATERAL MOVEMENT, UNDERMINING, WASHOUTS, AND OTHER HAZARDS CREATED BY SITE IMPROVEMENTS. IF ANY DAMAGE OCCURS, REPAIR TO ORIGINAL CONDITION AT NO ADDITIONAL COST.
- 5. PROTECT AND/OR RESTORE EXISTING LAWN WITH 4" DEPTH TOPSOIL AND NEW SOD, INCLUDING BUT NOT LIMITED TO ALL AREAS WITHIN CONSTRUCTION LIMITS. 6. VERIFY DIMENSIONS IN FIELD.

7. COORDINATE WORK WITH ALL OTHER TRADES. **PAVING NOTES:**

- 1. INSTALL ALL PAVING TO BE SMOOTH AND CONTINUOUS WITHOUT KINKS OR ABRUPT CHANGES.
- 2. MATCH LINE AND GRADE OF PAVEMENT, LAWN AND PLANTING AREAS TO EXISTING ADJACENT AREAS.
- 3. GRADE ALL PAVED SURFACES TO A MAXIMUM 5% SLOPE WITH A MAXIMUM CROSS SLOPE OF 2% AND A MINIMUM SLOPE OF 0.5%.
- 4. ADJUST UTILITY STRUCTURES TO MEET FINISH GRADE. 5. LAYOUT CONTROL JOINTS AT A MAX 6' O.C. AND EXPANSION JOINTS AT A MAX 30' O.C. UNLESS OTHERWISE NOTED. IF PAVEMENT IS ARCED, LAYOUT CONTROL JOINTS EQUALLY ALONG LENGTH OF ARC AND PERPENDICULAR TO CENTERLINE OF ARC UNLESS OTHERWISE NOTED. CONTROL JOINTS ARE TO BE TOOLED WITH A LIGHT BROOM FINISH.


FURNISHING NOTES:

- 1. CONFIRM ALL FURNISHING QUANTITIES AND DIMENSIONS WITH ENGINEER. 2. FOR FURNISHING DETAILS, SEE SHEETS 136
- 3. PROVIDE STAINLESS STEEL TAMPER PROOF FASTENERS.

LANDSCAPE NOTES:

WITH ENGINEER.

- 1. PLANT ALL MIXED PLANTING BEDS AS SHOWN ON PLANS. 2. CONTRACTOR IS RESPONSIBLE FOR RETURNING TO PLANT FALL BULBS IF BULB PLANTING SEASON IS OVER AT TIME OF PROPOSED INSTALLATION, COORDINATE
- 3. FOR LANDSCAPE DETAILS, SEE SHEET 136 4. ALL PLANTINGS SHALL FOLLOW IDOT BUREAU OF DESIGN & ENVIRONMENT MANUAL -CHAPTER 59 - LANDSCAPE DESIGN AND EROSION CONTROL 59-7.09 PLANTING IN
- URBANIZED AREA FOR SIGHT DISTANCES. 5. ALL AREAS TO BE LANDSCAPED SHALL BE EXCAVATED TO THE DEPTH APPROPRIATE FOR THE PROPOSED PLANTINGS. EXCAVATION FOR LANDSCAPE AND SOD BED PREPARATION SHALL REMAIN OUTSIDE OF TREE PROTECTION ZONES OF EXISTING TREES. TREE PROTECTION ZONE SHOULD BE 1.5 FEET FROM TRUNK FOR EVERY 1" IN TRUNK DIAMETER BUT MAY BE REDUCED TO 1 FOOT FOR EVERY 1" TRUNK DIAMETER WITH APPROVAL OF THE ENGINEER OR EXTENUATING CIRCUMSTANCES.
- 6. ANY AREAS OUTSIDE OF THE LANDSCAPE BEDS THAT ARE DISTURBED SHALL BE REPLACED IN KIND.
- 7. NEW TREES TO BE PLANTED IN PROPOSED LANDSCAPE AREAS SHALL BE PLANTED AFTER SOIL/BED PREPARATION IS COMPLETE.

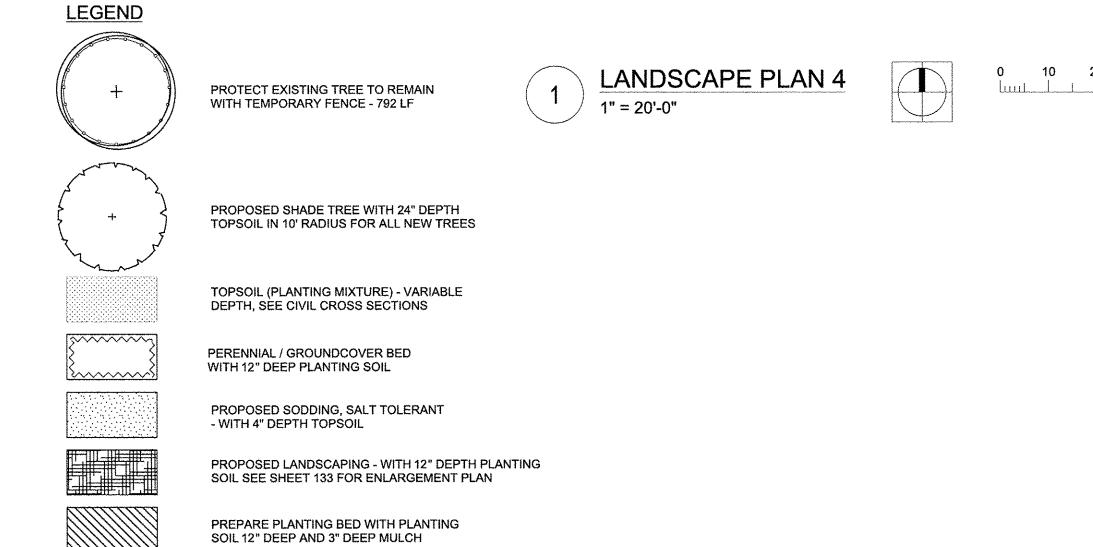

		PLANT SCHEDULE								
Ī	CODE	PAY ITEM	QUANTITY	BOTANICAL NAME	COMMON NAME	SIZE	ROOT	REMARKS		
	TT	XX006570	1	Tilia tomentosa	Silver Linden	3"-4" cal	B&B	matching heads		
Ī	LS	K0013000	1870	Liriope spicata	Lilyturf	2"	plug	8" o.c.		

FILE NAME =

P1-sht-GRNE-land04.dgn

PLOT DATE = 3/23/2016 11:44:01 AM

DESIGNED	-	ВК	REVISED	-
DRAWN	-	JR	REVISED	~
CHECKED	-	ВМ	REVISED	-
DATE	-	MARCH 2016	REVISED	_

PLANT QUANTITY


PLANT CODE

STATE OF ILLINOIS DEPARTMENT OF TRANSPORTATION LANDSCAPE PLAN - GREEN STREET

SCALE:: 1"=20'

SHEET NO. 131 OF 236 SHEETS | STA. 1017+50.00 TO STA. 1023+50.00

F.A.U. RTE. COUNTY SECTION CHAMPAIGN 236 131 15-00304-01-PV CONTRACT NO.91539 MCORE PROJECT I JOB NO. C-95-305-16 | ILLINOIS | FED. AID PROJECT TIG-5181(057)

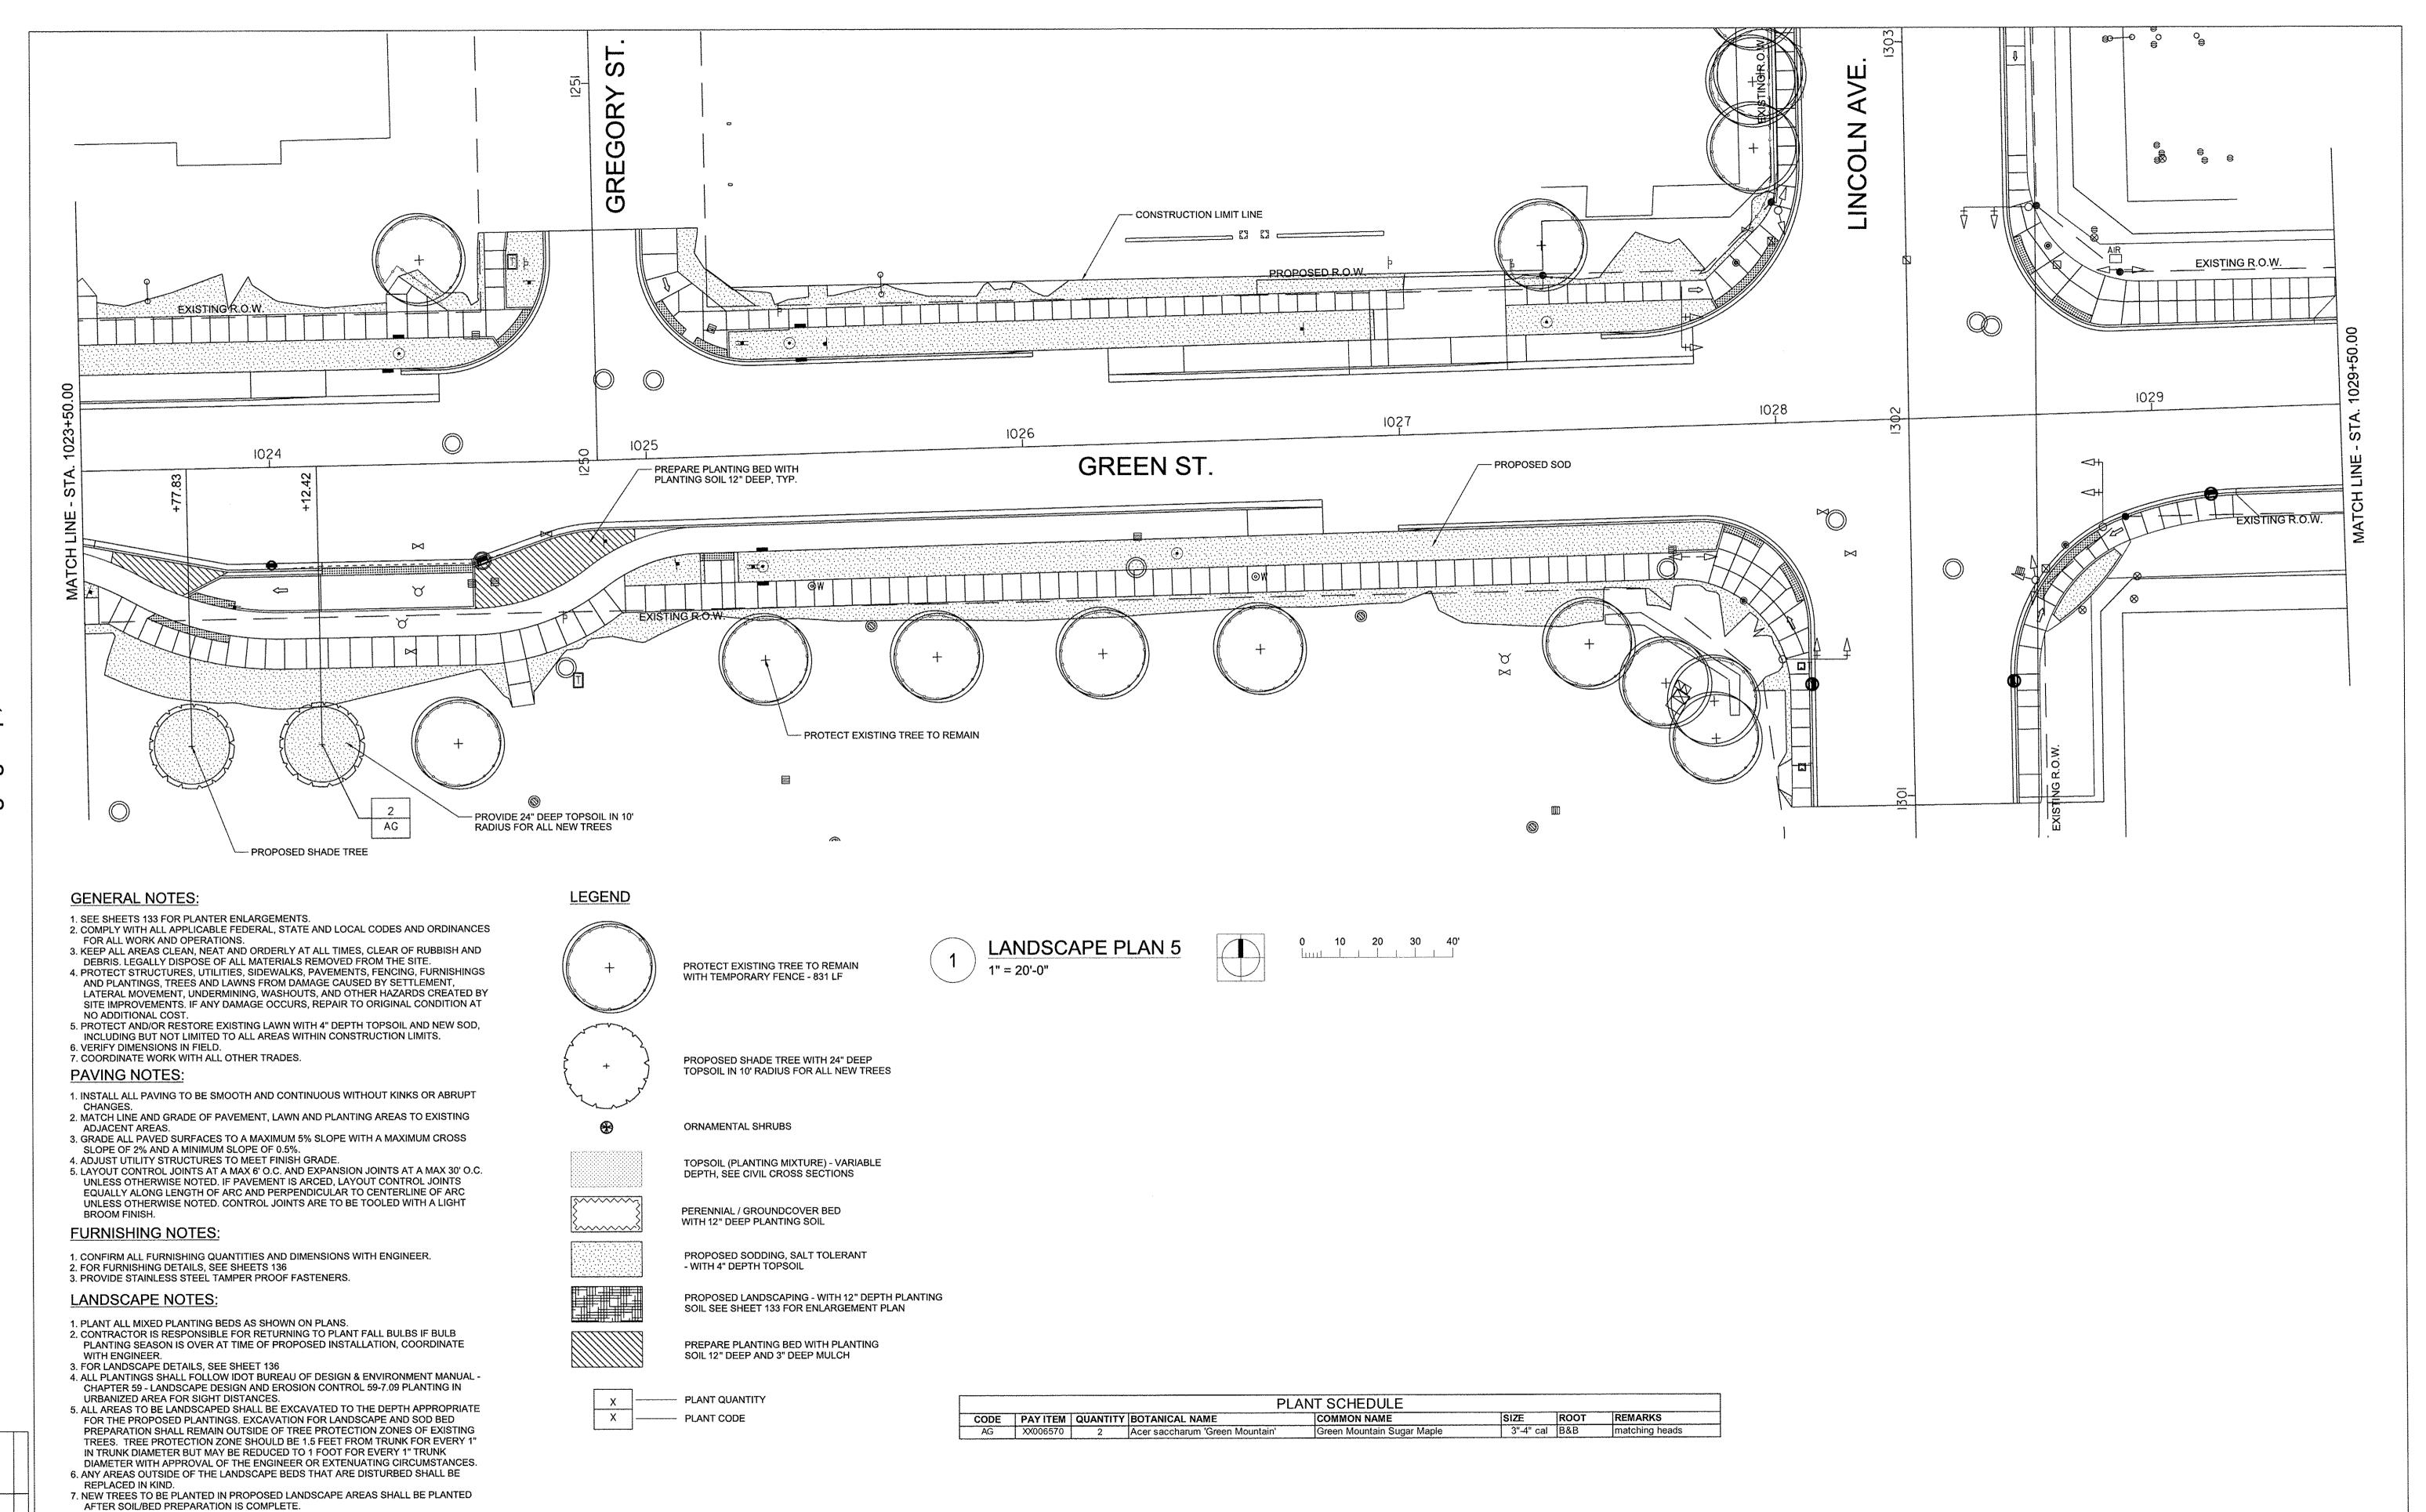

P1-sht-GRNE-land05.dgn PLOT DATE = 3/23/2016 2:40:51 PM

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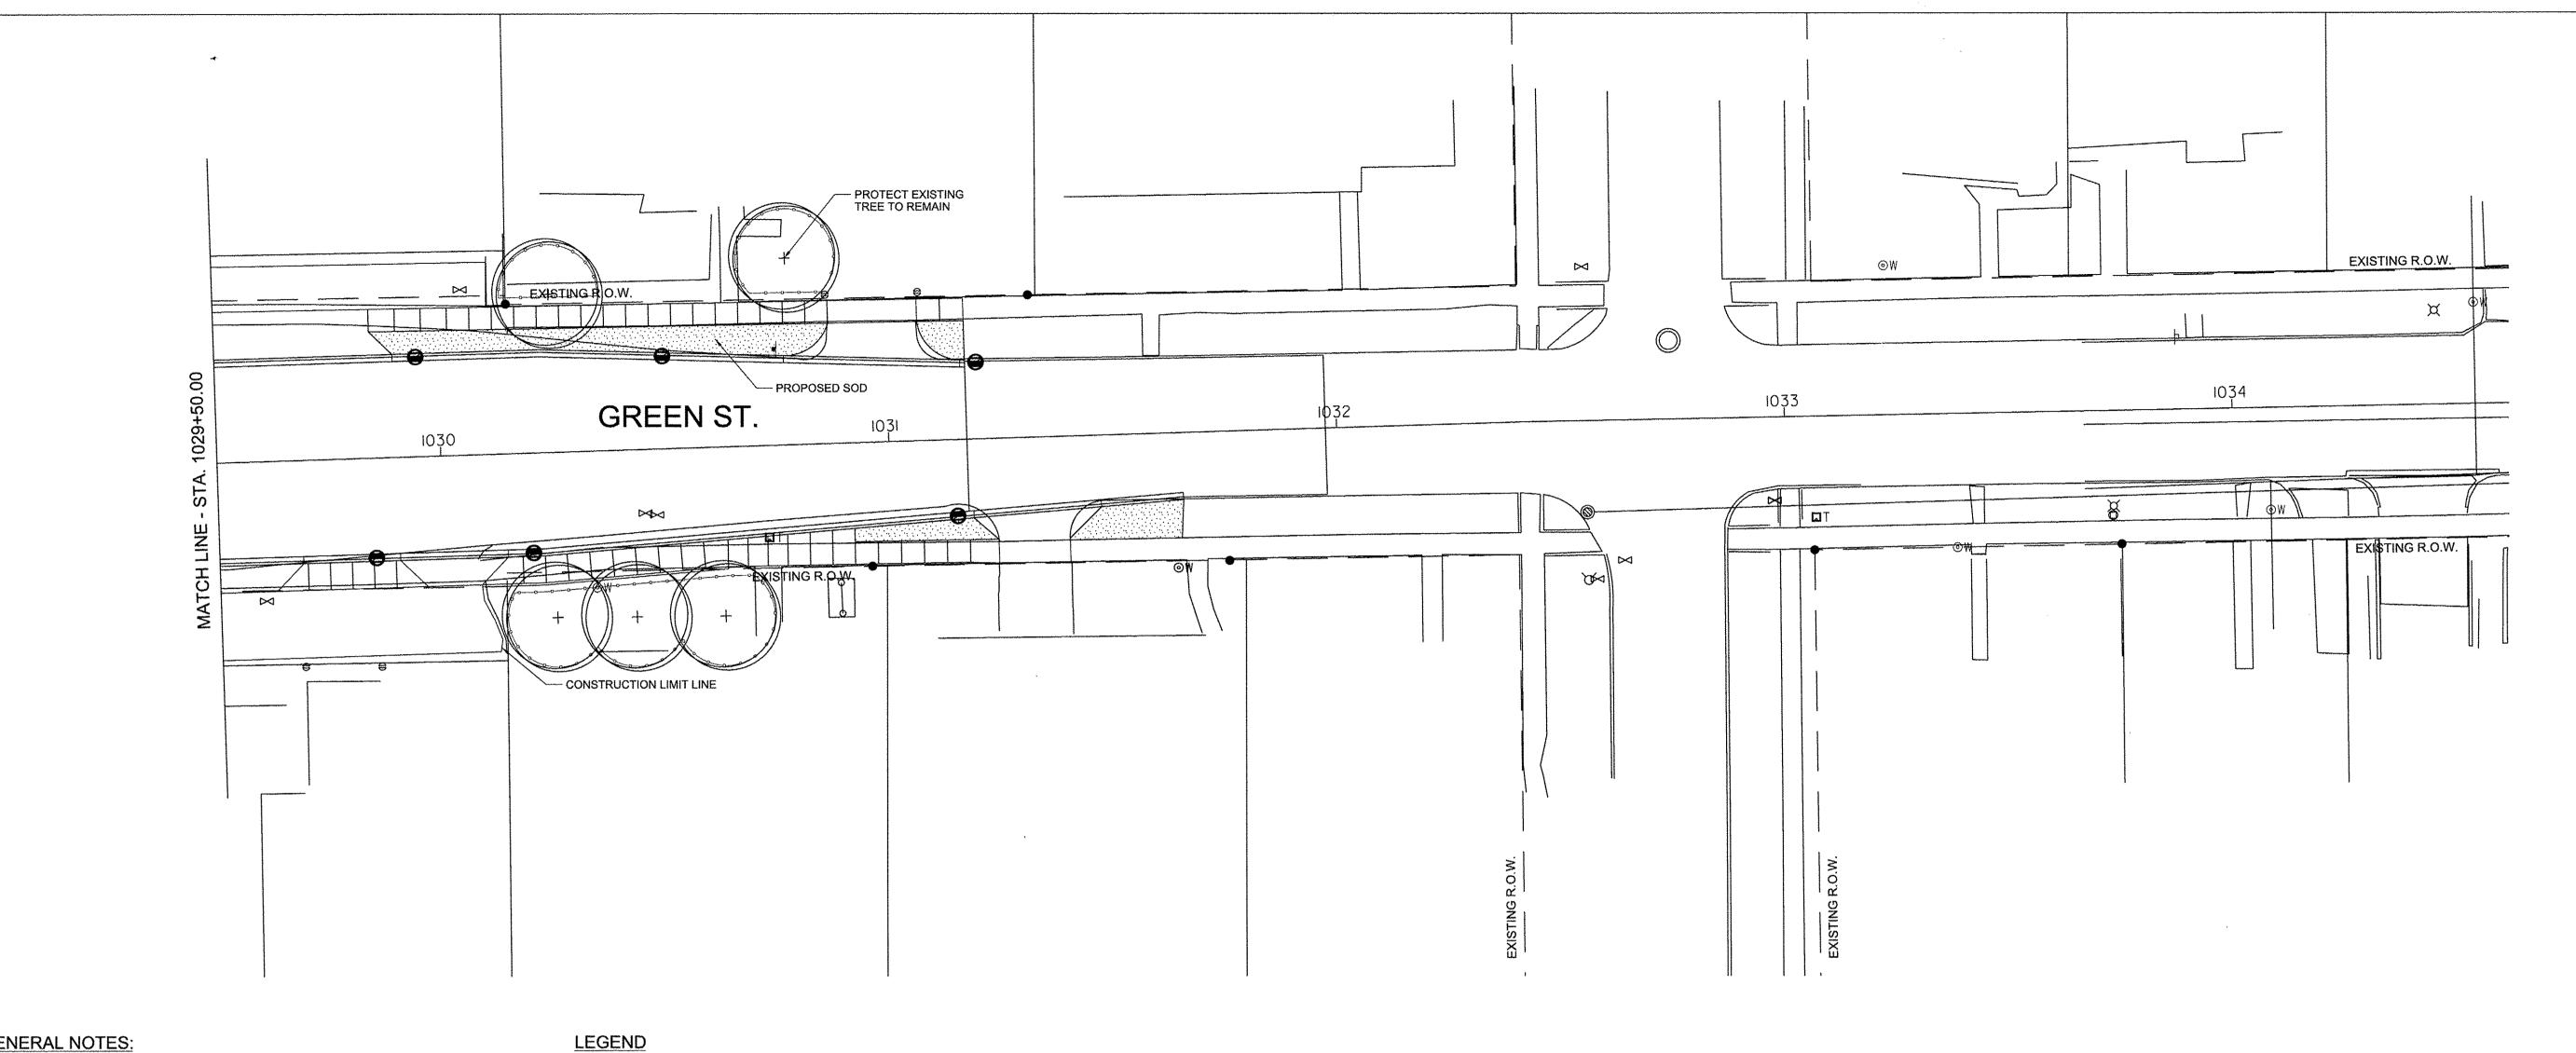
REVISED -DESIGNED - BK DRAWN - JR REVISED -BM REVISED CHECKED DATE MARCH 2016 REVISED

STATE OF ILLINOIS DEPARTMENT OF TRANSPORTATION

SECTION LANDSCAPE PLAN - GREEN STREET 15-00304-01-PV MCORE PROJECT |

CHAMPAIGN 236 132 CONTRACT NO.91539 SHEET NO. 132 OF 236 SHEETS | STA. 1023+50.00 TO STA. 1029+50.00 JOB NO. C-95-305-16 | ILLINOIS | FED. AID PROJECT TIG-5181(057) SCALE:: 1"=20'

COUNTY



GENERAL NOTES:

- SEE SHEETS 133 FOR PLANTER ENLARGEMENTS. 2. COMPLY WITH ALL APPLICABLE FEDERAL, STATE AND LOCAL CODES AND ORDINANCES
- FOR ALL WORK AND OPERATIONS. 3. KEEP ALL AREAS CLEAN, NEAT AND ORDERLY AT ALL TIMES, CLEAR OF RUBBISH AND
- DEBRIS. LEGALLY DISPOSE OF ALL MATERIALS REMOVED FROM THE SITE. 4. PROTECT STRUCTURES, UTILITIES, SIDEWALKS, PAVEMENTS, FENCING, FURNISHINGS AND PLANTINGS, TREES AND LAWNS FROM DAMAGE CAUSED BY SETTLEMENT, LATERAL MOVEMENT, UNDERMINING, WASHOUTS, AND OTHER HAZARDS CREATED BY SITE IMPROVEMENTS. IF ANY DAMAGE OCCURS, REPAIR TO ORIGINAL CONDITION AT
- NO ADDITIONAL COST. 5. PROTECT AND/OR RESTORE EXISTING LAWN WITH 4" DEPTH TOPSOIL AND NEW SOD, INCLUDING BUT NOT LIMITED TO ALL AREAS WITHIN CONSTRUCTION LIMITS.
- 6. VERIFY DIMENSIONS IN FIELD. 7. COORDINATE WORK WITH ALL OTHER TRADES.

PAVING NOTES:


- 1. INSTALL ALL PAVING TO BE SMOOTH AND CONTINUOUS WITHOUT KINKS OR ABRUPT CHANGES.
- 2. MATCH LINE AND GRADE OF PAVEMENT, LAWN AND PLANTING AREAS TO EXISTING
- ADJACENT AREAS. 3. GRADE ALL PAVED SURFACES TO A MAXIMUM 5% SLOPE WITH A MAXIMUM CROSS
- SLOPE OF 2% AND A MINIMUM SLOPE OF 0.5%. 4. ADJUST UTILITY STRUCTURES TO MEET FINISH GRADE.
- 5. LAYOUT CONTROL JOINTS AT A MAX 6' O.C. AND EXPANSION JOINTS AT A MAX 30' O.C. UNLESS OTHERWISE NOTED. IF PAVEMENT IS ARCED, LAYOUT CONTROL JOINTS EQUALLY ALONG LENGTH OF ARC AND PERPENDICULAR TO CENTERLINE OF ARC UNLESS OTHERWISE NOTED. CONTROL JOINTS ARE TO BE TOOLED WITH A LIGHT BROOM FINISH.

FURNISHING NOTES:

- 1. CONFIRM ALL FURNISHING QUANTITIES AND DIMENSIONS WITH ENGINEER.
- 2. FOR FURNISHING DETAILS, SEE SHEETS 136 3. PROVIDE STAINLESS STEEL TAMPER PROOF FASTENERS.


LANDSCAPE NOTES:

- 1. PLANT ALL MIXED PLANTING BEDS AS SHOWN ON PLANS. 2. CONTRACTOR IS RESPONSIBLE FOR RETURNING TO PLANT FALL BULBS IF BULB PLANTING SEASON IS OVER AT TIME OF PROPOSED INSTALLATION, COORDINATE WITH ENGINEER.
- 3. FOR LANDSCAPE DETAILS, SEE SHEET 136
- 4. ALL PLANTINGS SHALL FOLLOW IDOT BUREAU OF DESIGN & ENVIRONMENT MANUAL -CHAPTER 59 - LANDSCAPE DESIGN AND EROSION CONTROL 59-7.09 PLANTING IN URBANIZED AREA FOR SIGHT DISTANCES.
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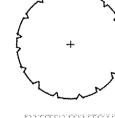


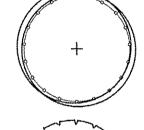PROTECT EXISTING TREE TO REMAIN WITH TEMPORARY FENCE - 275 LF




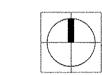


SCALE:: 1"=20'



PROPOSED SHADE TREE WITH 24" DEEP TOPSOIL IN 10' RADIUS FOR ALL NEW TREES

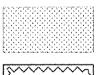


TOPSOIL (PLANTING MIXTURE) - VARIABLE DEPTH, SEE CIVIL CROSS SECTIONS

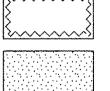

WITH 12" DEEP PLANTING SOIL PROPOSED SODDING, SALT TOLERANT

- WITH 4" DEPTH TOPSOIL


PERENNIAL / GROUNDCOVER BED

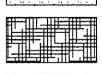

PROPOSED LANDSCAPING - WITH 12" DEPTH PLANTING SOIL SEE SHEET 133 FOR ENLARGEMENT PLAN



PREPARE PLANTING BED WITH PLANTING SOIL 12" DEEP AND 3" DEEP MULCH

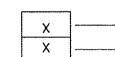

PLANT QUANTITY PLANT CODE

FILE NAME =


P1-sht-GRNE-land06.dgn PLOT DATE = 3/23/2016 11:45:49 AM


DESIGNED	-	ВК	REVISED	79
DRAWN	#	JR	REVISED	-
CHECKED	_	ВМ	REVISED	
DATE	-	MARCH 2016	REVISED	*

STATE OF ILLINOIS DEPARTMENT OF TRANSPORTATION


F.A.U. RTE. LANDSCAPE PLAN - GREEN STREET SHEET NO. 133 OF 236 SHEETS | STA. 1029+50.00 TO STA.

COUNTY SECTION 15-00304-01-PV CHAMPAIGN 236 133 MCORE PROJECT | CONTRACT NO.91539 JOB NO. C-95-305-16 | ILLINOIS | FED. AID PROJECT TIG-5181(057)

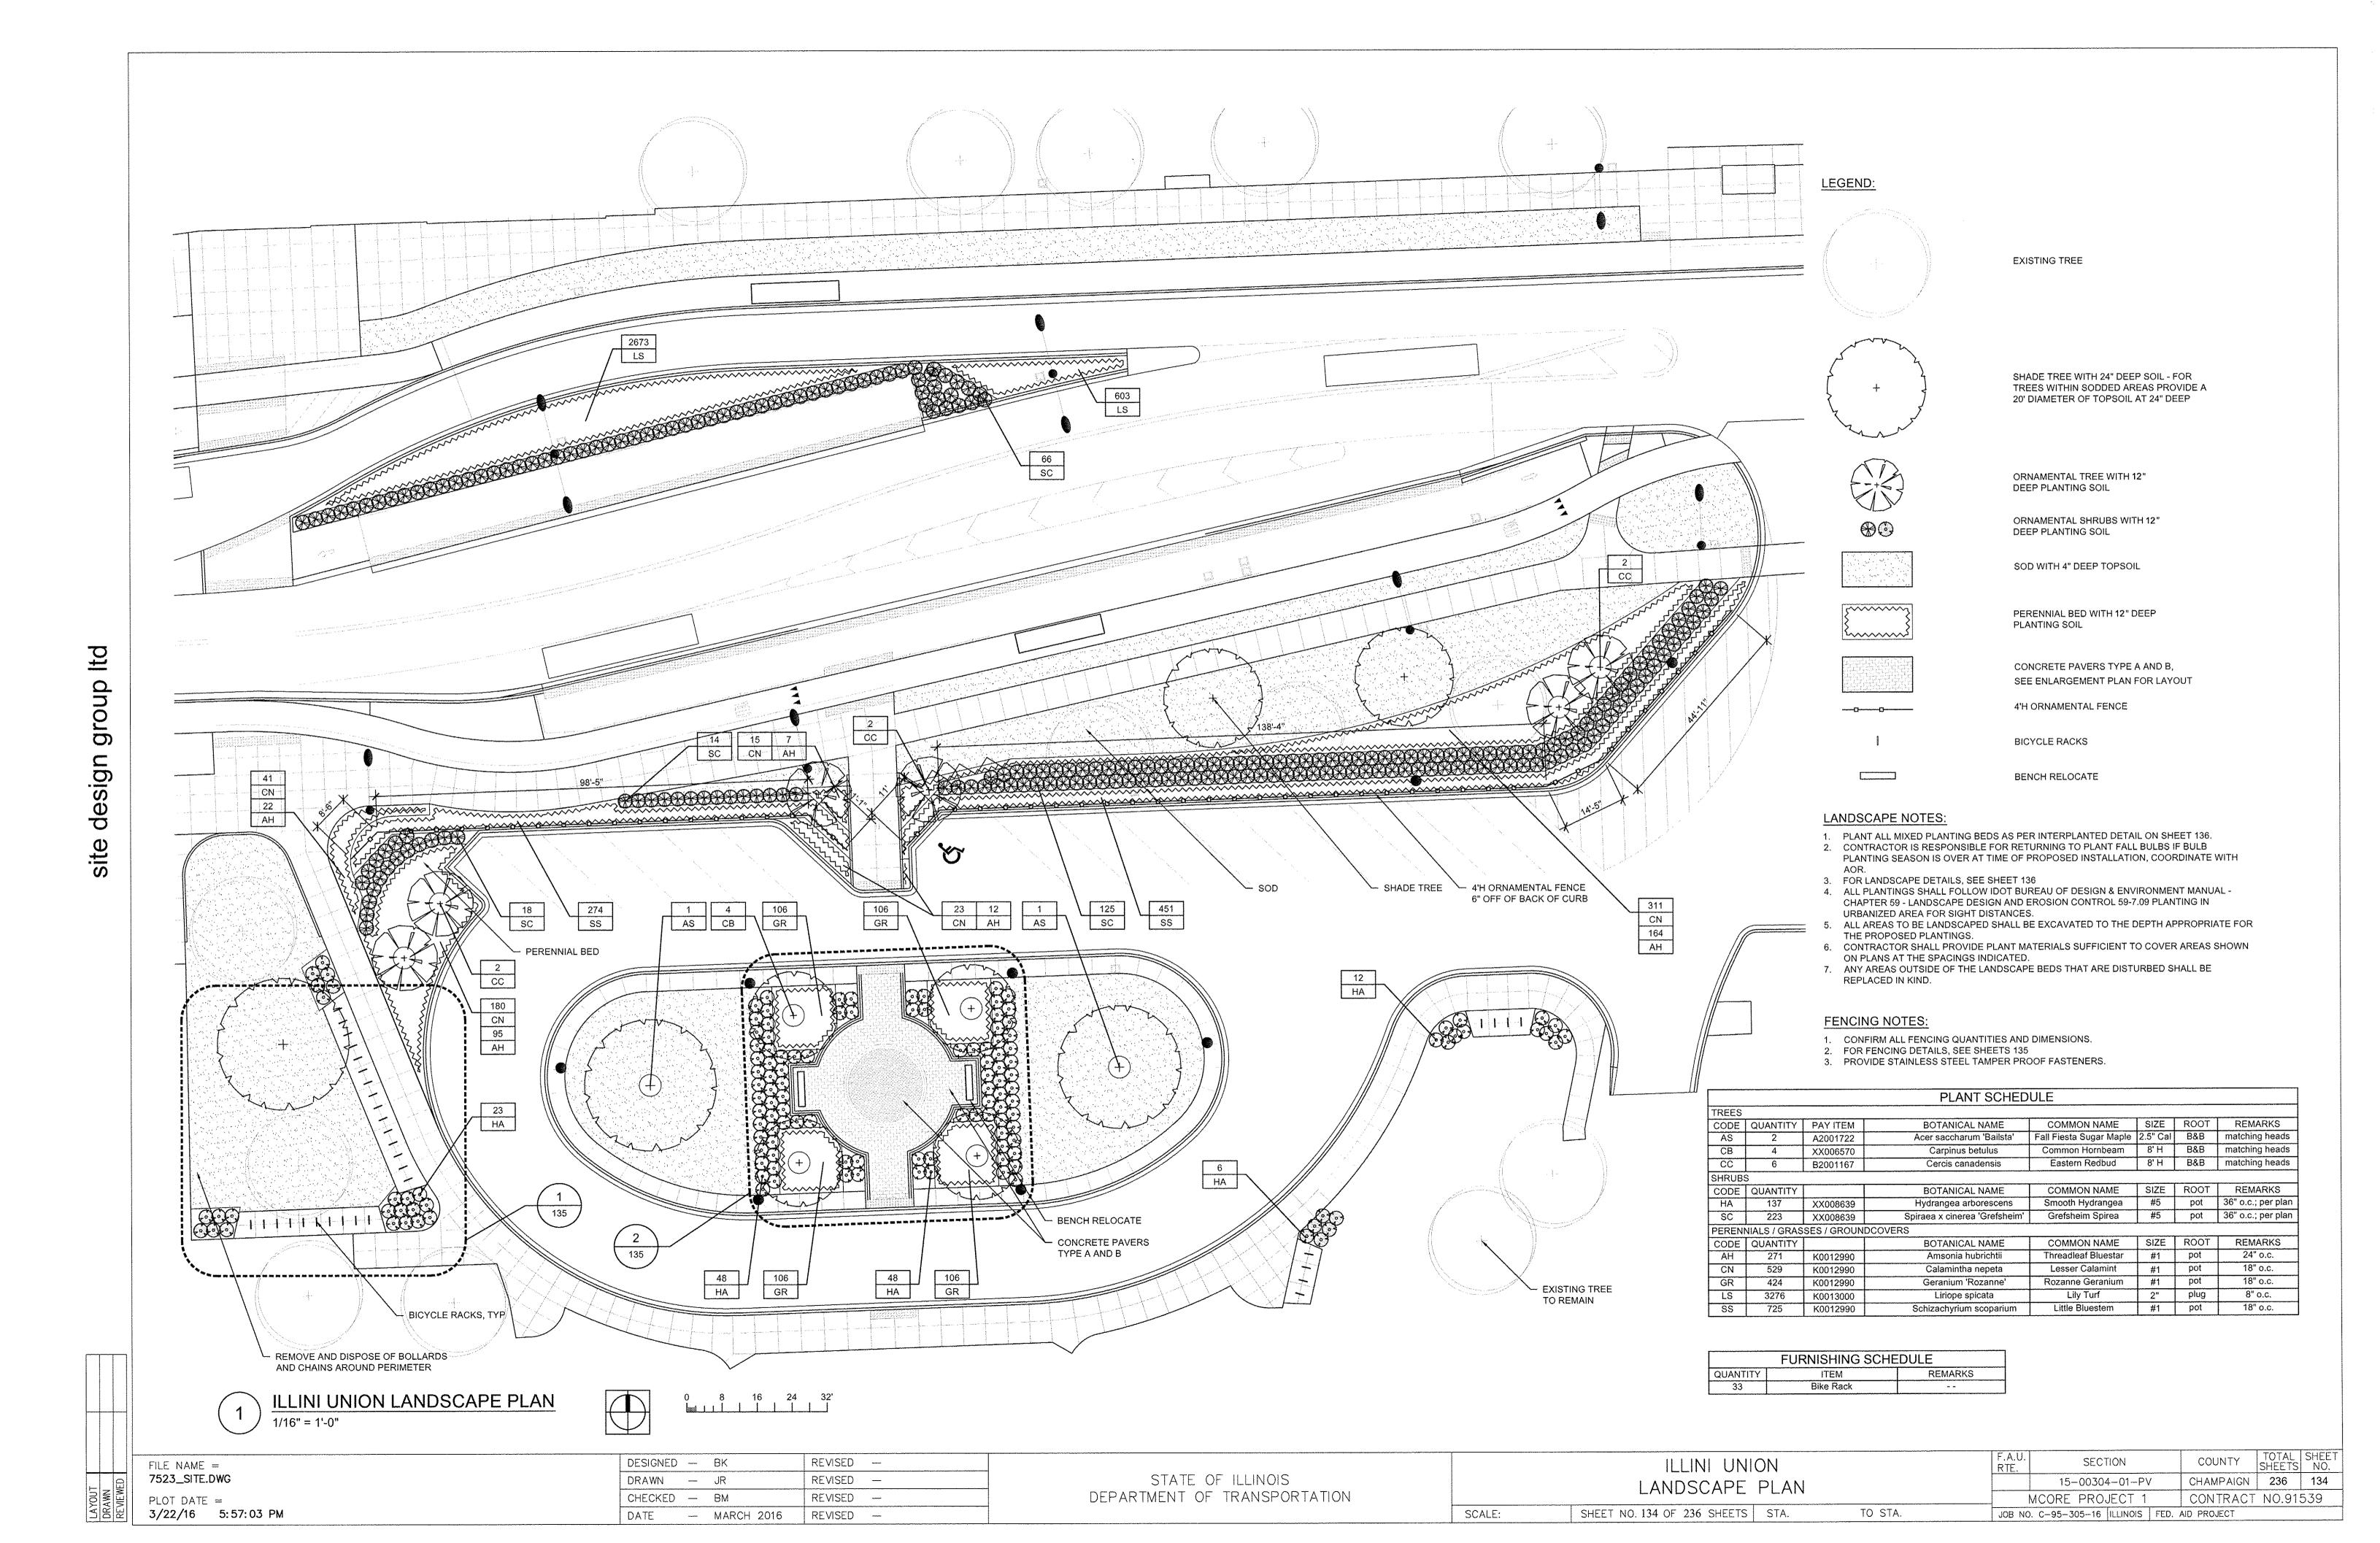


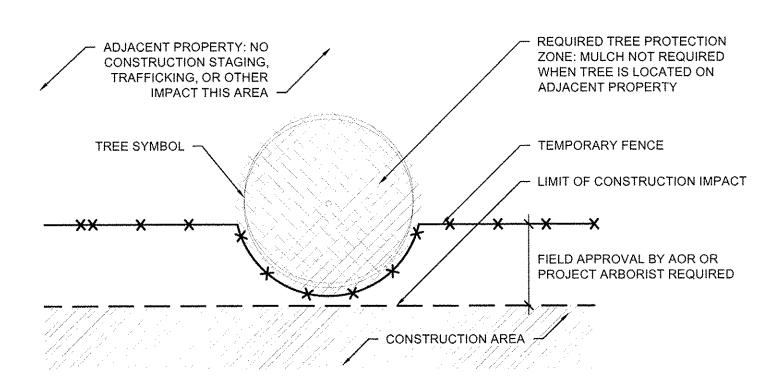

TEMPORARY FENCE INTERSECTS PROPERTY LIMIT; NO ROOT PRUNING REQUIRED PLAN NOT TO SCALE

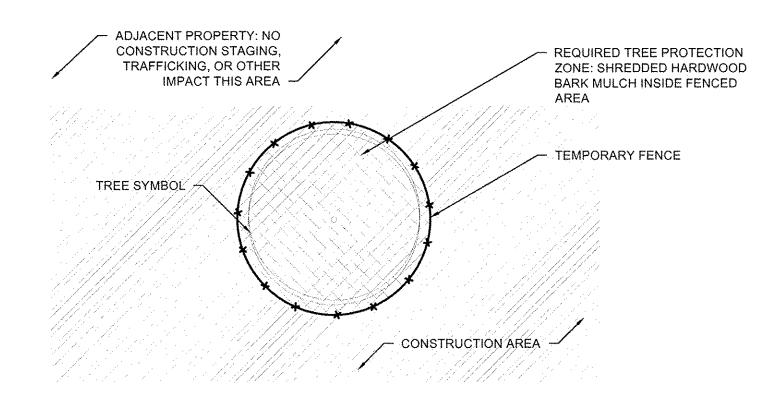

TREE PROTECTION ENTIRELY WITHIN CONSTRUCTION AREA PLAN NOT TO SCALE

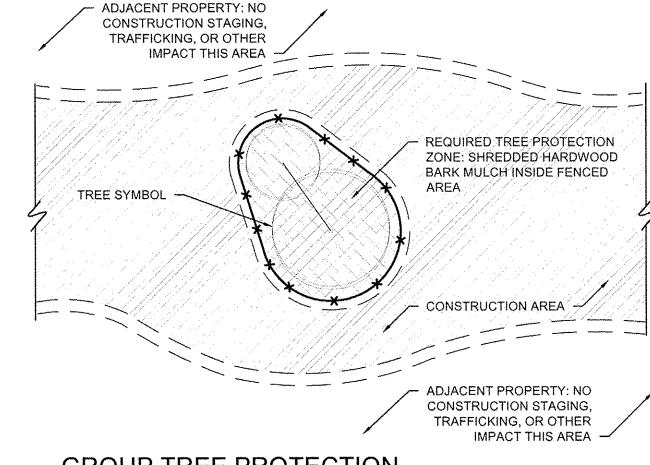

GROUP TREE PROTECTION ENTIRELY WITHIN CONSTRUCTION AREA PLAN NOT TO SCALE

TREE PROTECTION NOTES:

- THE PROTECTION OF TREES IS EXTREMELY IMPORTANT. TREE PROTECTION DEFICIENCIES ARE DETERMINED BY THE CERTIFIED ARBORIST AND MAY INCLUDE BUT ARE NOT LIMITED

TREE PROTECTION NOT IN PLACE AT THE START OF CONSTRUCTION.

TEMPORARY FENCING DAMAGED OR DOWN.

CONTRACTOR VEHICLES OR EQUIPMENT OR PERSONAL VEHICLES DRIVING OR PARKING

4. ANY ENCROACHMENT IN TEMPORARY FENCING PLACEMENT OF ANY MATERIAL WITHIN THE TEMPORARY FENCING OR TREE DRIPLINES


DAMAGE TO ANY TREE

UNAUTHORIZED REMOVAL OF TREES

UNAUTHORIZED CHANGES IN GRADE - THE CONTRACTOR MUST HAND DIG WHEN IN THE DRIPLINE OF PROTECTED TREES. - IN THE EVENT THAT A TREE IS DAMAGED BY THE CONTRACTOR'S OPERATION OR PERSONNEL, THE CONTRACTOR SHALL BE RESPONSIBLE FOR REPAIR OR REMEDIATION OF THE DAMAGE AS DETERMINED BY THE CERTIFIED ARBORIST AND/OR UNIVERSITY OF ILLINOIS AND BUREAU OF FORESTRY. IN THE EVENT THAT THE DAMAGE TO THE TREE IS BEYOND REPAIR AND REQUIRES REMOVAL OR THE CONTRACTOR MISTAKENLY REMOVED THE TREE, THE TREE MUST BE REPLACED AT THE CONTRACTOR'S EXPENSE. AT A MINIMUM ANY TREE GREATER THAN 4" SHALL BE REPLACED WITH A NEW TREE AS IDENTIFIED BY THE UNIVERSITY AND/OR BUREAU OF FORESTRY AND SHALL HAVE A MINIMUM OF 4" CALIPER B&B. ANY DAMAGED TREE SMALLER THAN 4" CALIPER MEASURED

6" ABOVE GROUND SHALL BE REPLACED IN KIND, INCH FOR INCH. - THE QUALITY OF THE REPLACEMENT TREE MUST BE EQUIVALENT TO THE STANDARDS OF THE BUREAU OF FORESTRY. THE COST OF THIS WORK WILL BE THE RESPONSIBILITY OF THE CONTRACTOR.

TEMPORARY FENCING SCHEDULE					
QUANTITY ITEM REMARKS					
3,756 LF	Temporary Fence				

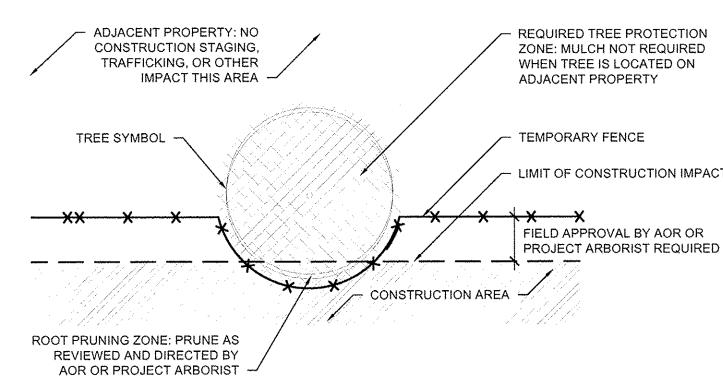

TEMPORARY FENCE INTERSECTS PROPERTY LIMIT; ROOT PRUNING REQUIRED PLAN NOT TO SCALE

TEMPORARY FENCE DELINEATES TREE

PROTECTION ZONE PER TREE


ENCLOSED BY FENCE WITH 3"

PROTECTION TABLE. MULCH AREA

SHREDDED HARDWOOD BARK MULCH.

TEMPORARY FENCE INTERSECTS PROPERTY LIMIT;

NO ROOT PRUNING REQUIRED ELEVATION

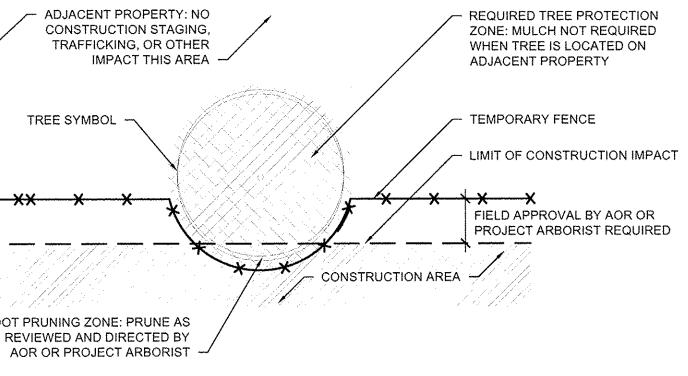

EXISTING TREE OR TREES TO BE PROTECTED

TEMPORARY FENCE:


TEMPORARY FENCE

EACH 1" DBH


LOCATED 1' FROM TRUNK FOR

TEMPORARY FENCE, SEE

TEMPORARY FENCE NOT TO SCALE

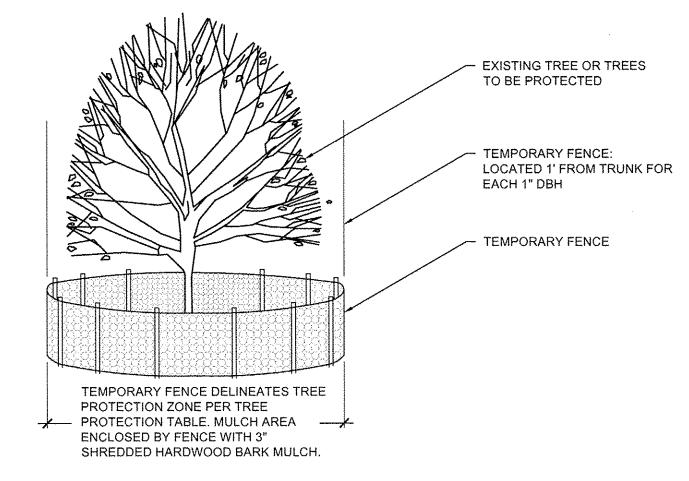

TREE PROTECTION ENTIRELY WITHIN CONSTRUCTION AREA ELEVATION NOT TO SCALE

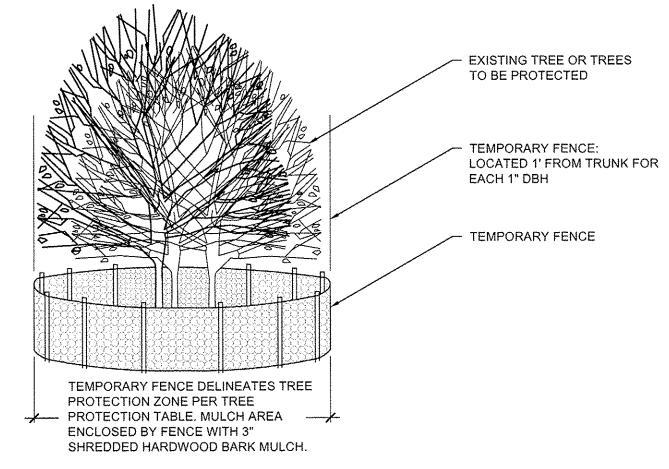

GROUP TREE PROTECTION ENTIRELY WITHIN CONSTRUCTION AREA ELEVATION NOT TO SCALE

4		* ************************************	1× 2000200000	SPECIFICATIONS POST SPACING 5' (1.5M) O.C. MINIMUM OR AS REQUIRED
				TO MAINTAIN FENCE - TEMPORARY FENCE
***************************************	VARIES	o		(VARIES, SEE SPECIFICATIONS)
	m Ø			- EXISTING GRADE
	36" FOR 6' HEIGHT FENCE			

NONE, TREE PROTECTED BY ADJACENT PROPERTY NONE TEMPORARY FENCE AT PROJECT LIMITS 1'-5" RADIUS FOR EACH 1" (2.54 cm) DBH*, YES, 3" DEPTH OF HARDWOOD TREE WITH TEMPORARY OR AS APPROVED BY ENGINEER OR BARK MULCH, NOT IN PROJECT ARBORIST CONTACT WITH THE TRUNK TREE WITH TEMPORARY 1'-5" RADIUS FOR EACH 1" (2.54 cm) DBH*, YES, 3" DEPTH OF HARDWOOD FENCE, ROOTPRUNED OR AS APPROVED BY ENGINEER OR YELLOW BARK MULCH, NOT IN PROJECT ARBORIST CONTACT WITH THE TRUNK TREE TO BE REMOVED RED NONE, TREES MUST BE REMOVED PRIOR TO START OF CONSTRUCTION

RADIUS OF TREE CHAIN LINK

PROTECTION FENCE FROM TRUNK

*DBH - DIAMETER AT BREAST HEIGHT MEASURED AT 4.5' FROM BASE OF TREE.

COLOR



SCALE:

TREE PROTECTION

TREE PROTECTION TABLE AND NOTES

NOT TO SCALE

DESIGNED		BK	REVISED	_
DRAWN	_	JR	REVISED	_
CHECKED		ВМ	REVISED	
DATE		MARCH 2016	REVISED	

STATE OF ILLINOIS DEPARTMENT OF TRANSPORTATION

TREE	PROTECTION	DETAILS


SHEET NO. 135 OF 236 SHEETS | STA.

PROTECTION ZONE

TO STA.

.A.U. RTE.	SECTION	COUNTY	TOTAL SHEETS	SHEE NO.
	15-00304-01-PV	CHAMPAIGN	236	135
	MCORE PROJECT 1	CONTRACT	NO.91	539
IOB NO	C-95-305-16 INOIS FED	AID PROJECT		



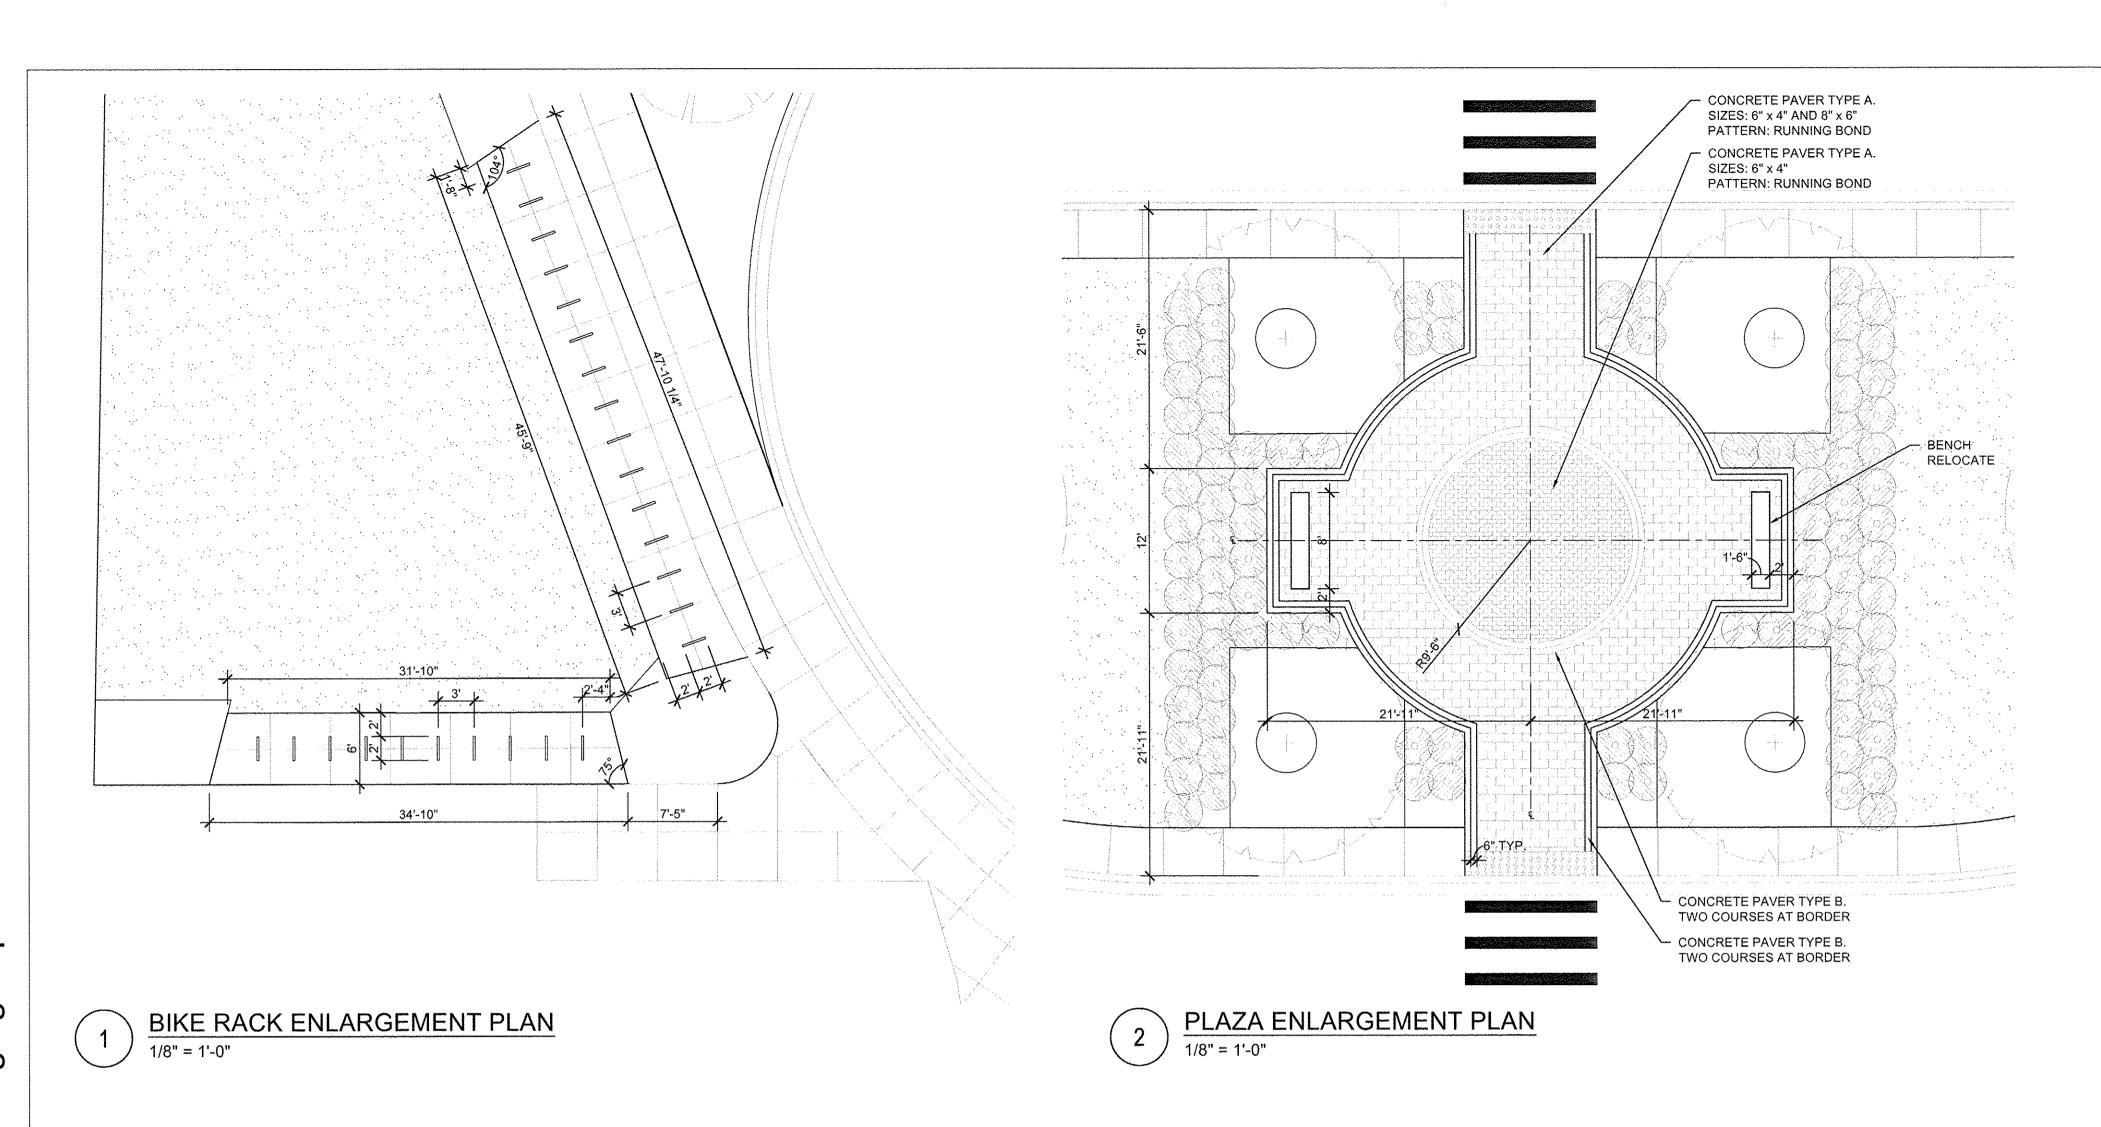

RELOCATED CONCRETE BENCH

CONCRETE PAVER TYPE A

1" MORTAR LEVELING BED


(3) #4 REBAR, EQUALLY SPACED

8" THICK CONCRETE SLAB


COMPACTED GRANULAR BASE

3 BENCH RELOCATE DETAIL


1" = 1'-0"

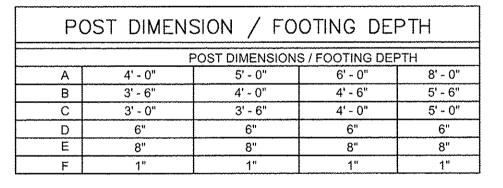

NOTE:
1. CORNER POSTS: 4" SQ.
2. INTERMEDIATE POSTS: 2-1/2" SQ.

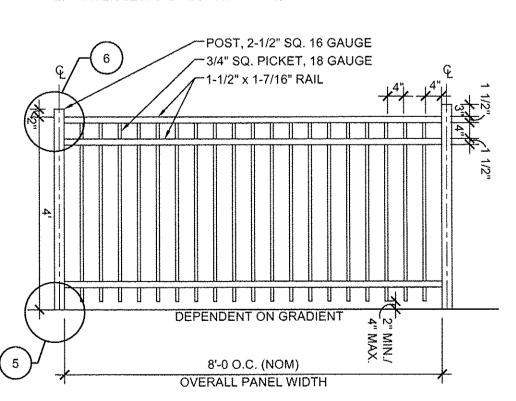


 $\frac{4'H ORNAMENTAL METAL FENCE DETAIL}{1/2" = 1'-0"}$

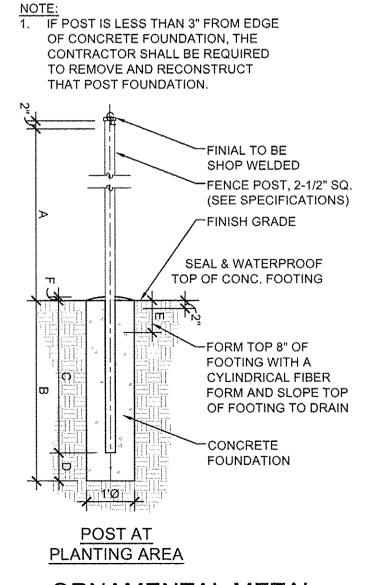


ORNAMENTAL METAL
FENCE POST FOOTING DETAIL

1/2" = 1'-0"

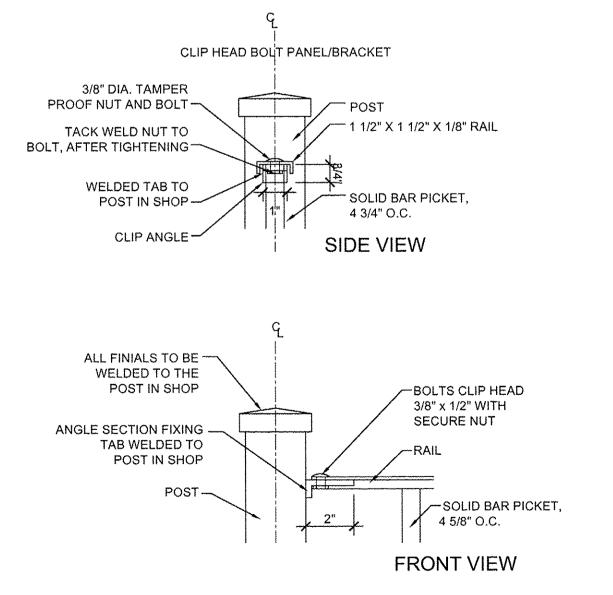

SCALE:

 $6) \frac{\text{POST CAP DETAIL}}{3" = 1'-0"}$

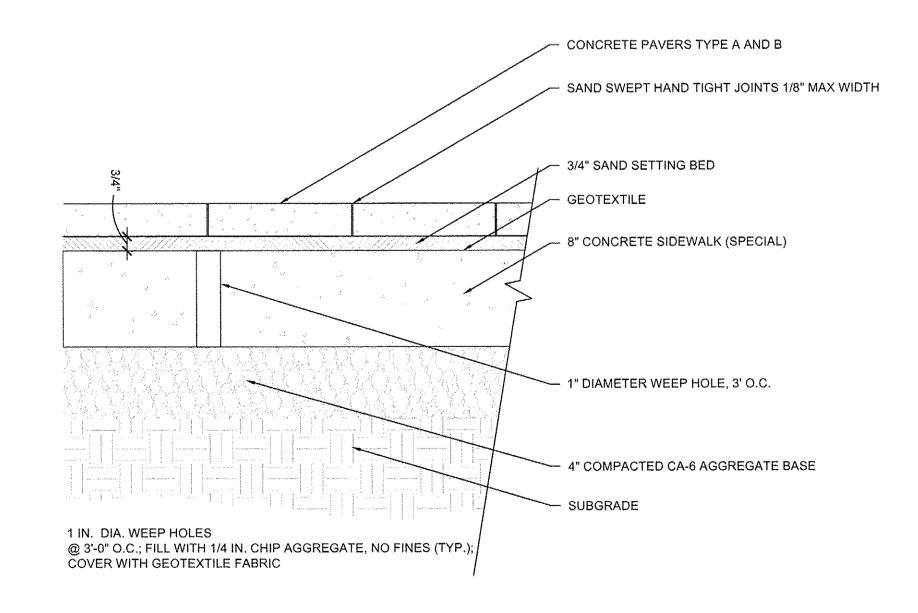

7 PRECAST CONCRETE PAVER DETAIL

1 1/2" = 1'-0"

FILE NAME	
7523_LAND	DTLS.DWG
PLOT DATE	
3/22/16	5: 57: 03 PM

DESIGNED		BK	REVISED	
DRAWN		JR	REVISED	
CHECKED	_	ВМ	REVISED	
DATE	_	MARCH 2016	REVISED	
	DRAWN CHECKED	CHECKED —	DRAWN — JR CHECKED — BM	DRAWN — JR REVISED CHECKED — BM REVISED

STATE OF ILLINOIS DEPARTMENT OF TRANSPORTATION


ILLINI UNION	F.A.U. RTE.	SECTION	COUNTY TOTAL SHEET SHEETS NO.
LANDSCAPE PLAN		15-00304-01-PV	CHAMPAIGN 236 136
LANDSOAL LILAN		MCORE PROJECT 1	CONTRACT NO.91539
SHEET NO. 136 OF 236 SHEETS STA. TO STA.	JOB NO	D. C-95-305-16 ILLINOIS FED.	AID PROJECT

FILE NAME =

PLOT DATE =


7523_LANDDTLS.DWG

3/22/16 5:57:03 PM

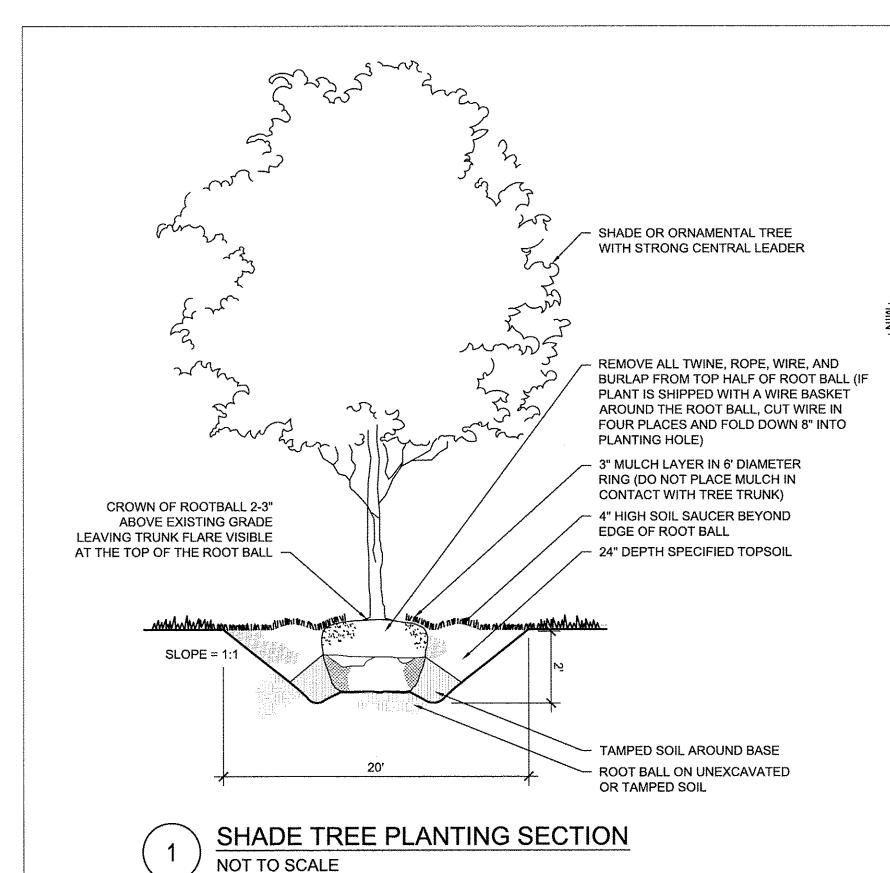


ROOT BALL WITH BURLAP 1/2 - CROWN OF ROOTBALL FLUSH WITH EXISTING GRADE 3" HARDWOOD MULCH LAYER IN SAUCER SHAPE FINISH GRADE SPECIFIED TOP SOIL FOR PLANTING EXISTING SUBGRADE/APPROVED ENGINEERING BARRIER ADJACENT MULCH IS TO BE 3" HARDWOOD MULCH.

NOT TO SCALE

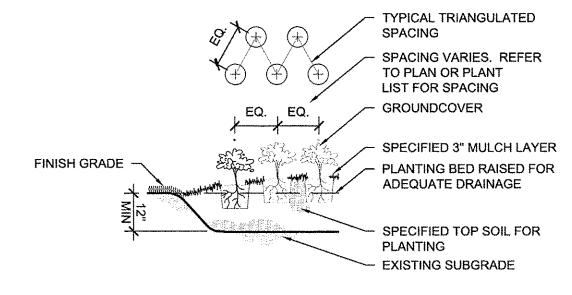

PERENNIAL PLANTING SECTION NOT TO SCALE

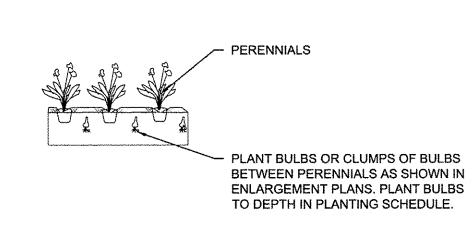


SHRUB PLANTING SECTION

HERBACEOUS FILLER TO BE PLANTED IN NATURALISTIC DRIFTS THROUGHOUT PLANT MATERIAL TRIANGULAR SPACING FOR ALL PLANT MATERIAL (TYP). SEE PLANT LIST FOR SPACING DISTANCE

BULB INSTALLATION DETAIL NOT TO SCALE

INTERPLANTING DETAIL NOT TO SCALE

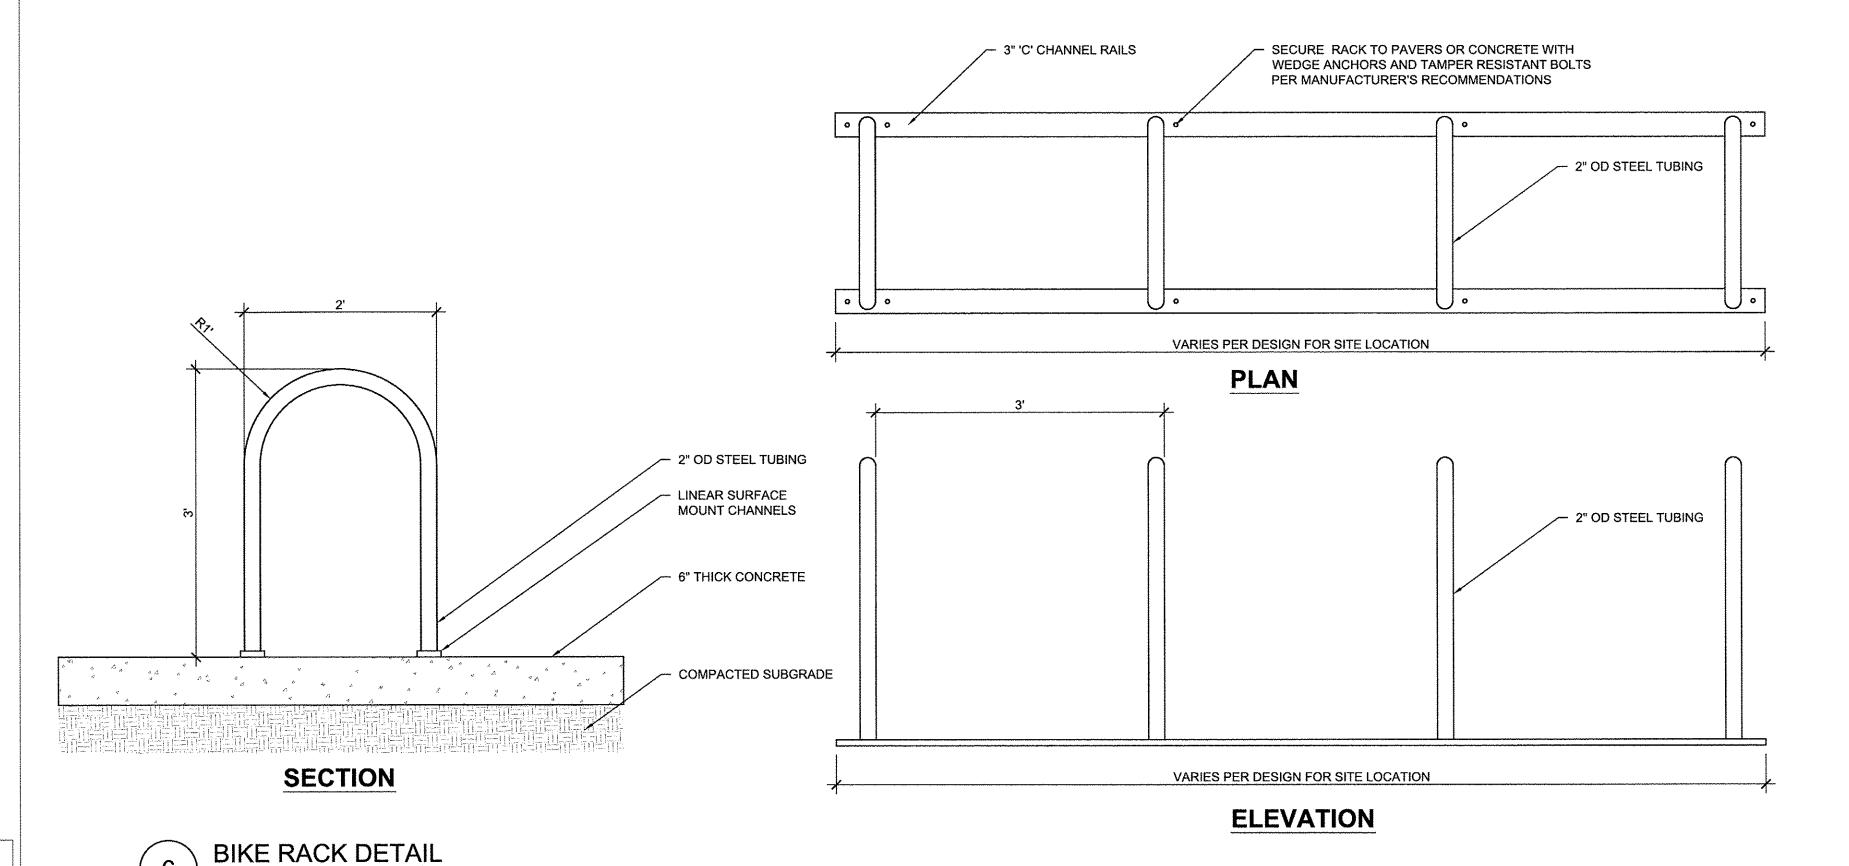

GENERAL PLANTING NOTES

- 1. DETERMINE EXACT LOCATIONS OF ALL UNDERGROUND UTILITIES AND VERIFY IN FIELD. REPORT ANY CONFLICTS TO ENGINEER PRIOR TO BEGINNING
- 2. INFORM ENGINEER AS EACH PHASE OF WORK IS UNDERTAKEN.
- 3. PROTECT EXISTING VEGETATION INCLUDING ALL EXISTING PARKWAY AND INTERIOR TREES. REPLACE DAMAGED VEGETATION WITH APPROVED SIMILAR MATERIAL.
- 4. MAINTAIN SITE DRAINAGE DURING LANDSCAPE INSTALLATION.
- 5. SLOPE ALL PLANTING AREAS AWAY FROM BUILDING AT 2% MINIMUM GRADE UNLESS NOTED OTHERWISE.
- 6. PRIOR TO LANDSCAPE INSTALLATION, VERIFY PLANTING AREAS ARE GRADED AT +/- 0.1 FOOT TO FINISH GRADE.
- 7. IN LANDSCAPE AREAS, FINISH GRADE TO 4" MINIMUM BELOW ADJACENT BUILDING FINISH FLOOR ELEVATION UNLESS NOTED OTHERWISE.
- 8. FINISH GRADE TO 1" BELOW FINISH PAVING SURFACE IN LAWN AREAS AND 2" BELOW IN PLANTING AREAS.
- 9. CONFIRM ALL PLANT QUANTITIES. PROVIDE PLANT MATERIALS SUFFICIENT TO COVER AREAS SHOWN ON PLANS AT THE SPACINGS INDICATED.
- 10. PROVIDE SINGLE TRUNK STANDARD TREES UNLESS NOTED OTHERWISE.
- 11. PROVIDE IDENTIFICATION TAG FROM THE SUPPLYING NURSERY SHOWING COMMON AND BOTANICAL PLANT NAMES FOR AT LEAST ONE PLANT OF EACH SPECIES DELIVERED TO THE SITE. PROTECT ALL PLANTS AGAINST HEAT, SUN, WIND AND FROST DURING TRANSPORTATION TO THE SITE AND WHILE BEING HELD AT THE SITE. DO NOT STORE PLANTS IN TOTAL DARKNESS MORE THAN ONE DAY.
- 12. DO NOT DAMAGE PLANT ROOT BALL DURING TRANSPORTATION OR PLANTING.
- 13. NOTIFY THE ENGINEER AT THE TIME OF DELIVERY OF ANY PLANT MATERIAL THAT IS DAMAGED OR IN POOR CONDITION.
- 14. ENGINEER RESERVES THE RIGHT TO INSPECT ALL PLANT MATERIALS BEFORE PLANTING. MATERIAL MAY BE REJECTED AT ANY TIME DUE TO CONDITION, FORM OR DAMAGE BEFORE OR AFTER PLANTING.
- 15. REMOVE ALL ROCK AND DEBRIS 1" AND LARGER FROM PLANTING AREAS. LEGALLY DISPOSE ALL EXCESS MATERIALS RESULTING FROM THE WORK.
- 16. IN PLANTING SOIL PIT, REMOVE CRUSHED AGGREGATE TO AN ADEQUATE DEPTH TO ENSURE THAT NO PART OF THE PLANT MATERIAL IS IN CONTACT OR AFFECTED BY THE LIME OR LIMESTONE IN THE AGGREGATE
- 17. PROVIDE NEW TOPSOIL THAT IS FERTILE, FRIABLE AND NATURAL LOAM SURFACE SOIL, REASONABLY FREE OF SUBSOIL, CLAY, CLAY, LUMPS, BRUSH, WEEDS, AND OTHER LITTER AND FREE OF ROOTS, STUMPS, STONES LARGER THAN 2" IN ANY DIMENSION AND OTHER EXTRANEOUS OR TOXIC MATTER HARMFUL TO PLANT GROWTH, OBTAIN TOPSOIL FROM LOCAL SOURCES OR FROM AREAS HAVING SIMILAR SOIL CHARACTERISTICS TO THAT NECESSARY FOR VIGOROUS GROWTH OF SPECIFIED PLANTINGS. OBTAIN TOPSOIL THAT OCCURS IN A DEPTH OF NOT LESS THAN 6". DO NOT OBTAIN SOIL FROM BOGS OR MARSHES.
- 18. MIX SOIL AMENDMENTS AND FERTILIZERS WITH TOPSOIL ON A SITE SPECIFIC BASIS AT RATES APPROPRIATE FOR PLANTINGS IN ACCORDANCE WITH IDOT'S STANDARD SPECIFICATIONS.
- 19. STAKE LOCATION OF ALL TREES, HEDGE LINES AND PLANTING BEDS AND NOTIFY ENGINEER FOR REVIEW PRIOR TO PLANTING.
- 20. THE PLANTING PLANS ARE DIAGRAMMATIC. SPOT PLANT MATERIALS APPROXIMATELY AS SHOWN ON THE LANDSCAPE DRAWING AND NOTIFY ENGINEER FOR REVIEW BEFORE REMOVING FROM CONTAINERS.
- 21. INSTALL ALL PLANT MATERIAL IN ACCORDANCE WITH DETAILS AND SPECIFICATIONS.
- 22. REMOVE ALL PLANT TYING MATERIAL AND MARKING TAPES AT THE TIME OF PLANTING.
- 23. INSTALL A MIN 3" LAYER OF HARDWOOD BARK MULCH AROUND ALL TREES AND IN ALL PLANTING AREAS UNLESS NOTED OTHERWISE. CREATE A NATURAL SPADED EDGE WHERE PLANTING BEDS MEET TURF AREAS.
- 24. WATER ALL PLANTS IMMEDIATELY AFTER PLANTING. FLOOD PLANTS TWICE DURING FIRST TWENTY-FOUR HOUR PERIOD OF PLANTING.
- 25. GUY AND STAKE TREES, AS DIRECTED BY ENGINEER, IMMEDIATELY AFTER PLANTING. PROVIDE A MINIMUM OF TWO GUY WIRES PER TREE ON THE UPHILL SIDE OF TREES PLANTED ON SLOPES STEEPER THAN 3:1.
- 26. PRUNE ALL DECIDUOUS SHADE TREES FOR A MINIMUM LOWEST BRANCH HEIGHT OF 7 FEET.
- 27. INSTALL AND MAINTAIN SOD TO PREVENT EVIDENT SEAMS.
- 28. WARRANTY ALL PLANTS AND LAWN EXPERIENCING DEATH AND DEFECTS INCLUDING UNSATISFACTORY GROWTH, EXCEPT FOR DEFECTS RESULTING FROM NEGLECT BY OWNER, ABUSE OR DAMAGE BY OTHERS OR UNUSUAL PHENOMENON OR INCIDENTS WHICH ARE BEYOND CONTRACTOR'S

DESIGNED — BK	REVISED —			ILLINI UNION	F.A.U. SECTION	COUNTY TOTAL SHEET SHEET NO.
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CHECKED — BM	REVISED —	DEPARTMENT OF TRANSPORTATION		LANDSCAPE FLAN	MCORE PROJECT 1	CONTRACT NO.91539
DATE - MARCH 2016	REVISED —		SCALE:	SHEET NO. 137 OF 236 SHEETS STA. TO STA.	JOB NO. C-95-305-16 ILLINOIS FEC	D. AID PROJECT