


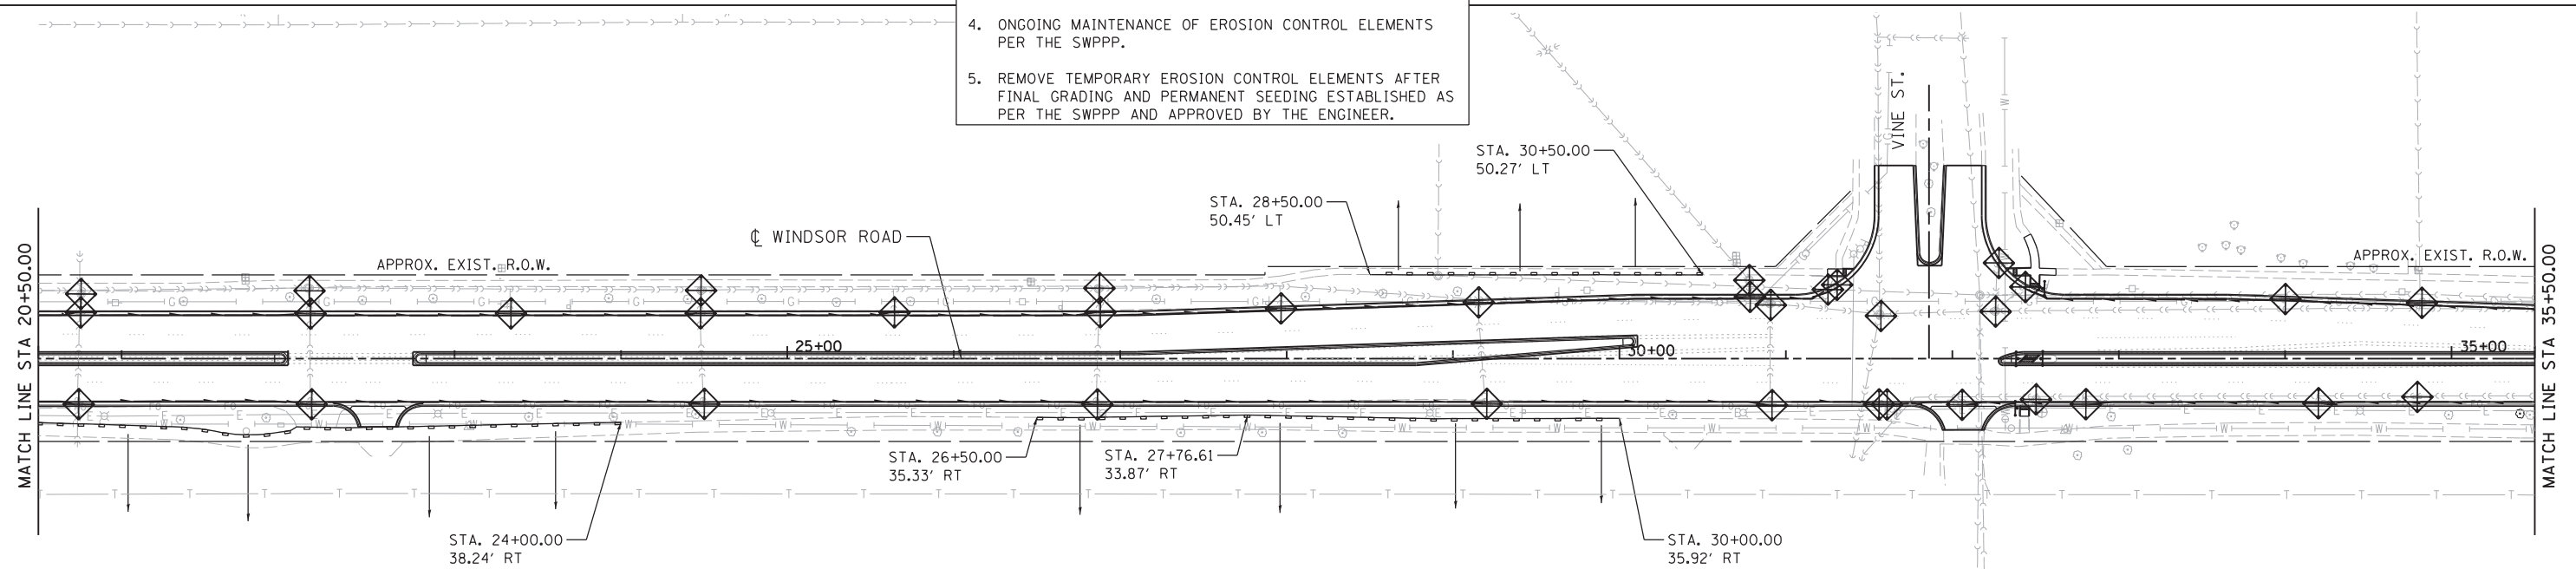
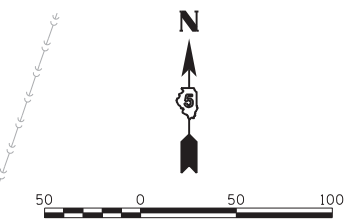





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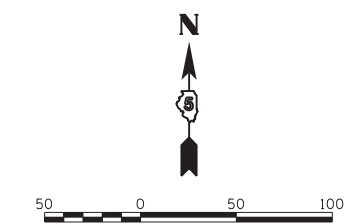
-  INLET FILTER - SEE SCHEDULES
-  PERIMETER EROSION BARRIER
-  DRAINAGE PATTERN DIRECTION

1. PLACEMENT OF PERIMETER EROSION BARRIER PRIOR TO COMMENCEMENT OF ANY WORK. SEE STANDARD 280001.
2. PLACEMENT OF INLET FILTERS AND PIPE PROTECTION PRIOR TO BEGINNING CONSTRUCTION. SEE STANDARD 280001.
3. PLACEMENT OF TEMPORARY SEEDING ON GRADED SURFACES NOT HAVING PERMANENT SEEDING APPLIED.
4. ONGOING MAINTENANCE OF EROSION CONTROL ELEMENTS PER THE SWPPP.
5. REMOVE TEMPORARY EROSION CONTROL ELEMENTS AFTER FINAL GRADING AND PERMANENT SEEDING ESTABLISHED AS PER THE SWPPP AND APPROVED BY THE ENGINEER.



**LEGEND**

-  INLET FILTER - SEE SCHEDULES
-  PERIMETER EROSION BARRIER
-  DRAINAGE PATTERN DIRECTION



DESIGNED	MH	4/29/14
DRAWN	RSJ	4/29/14
REVIEWED	MH	4/29/14


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MODEL NAME = Erosion Control	PLOT SCALE = 100.0000' / in.	DRAWN - RSJ	REVISED -
PENTABLE NAME = ...	PLOT DATE = 06/12/2014	CHECKED - MH	REVISED -
		DATE - 05-03-2014	REVISED -

**STATE OF ILLINOIS  
DEPARTMENT OF TRANSPORTATION**

**EROSION CONTROL  
WINDSOR ROAD**

SCALE: 1" = 50' SHEET 1 OF 3 SHEETS STA. TO STA.



F.A. RTE.	SECTION	COUNTY	TOTAL SHEETS	SHEET NO.
7145	13-00540-00-PV	CHAMPAIGN	80	34
	13L0201			CONTRACT NO. 91515
ILLINOIS FED. AID PROJECT				

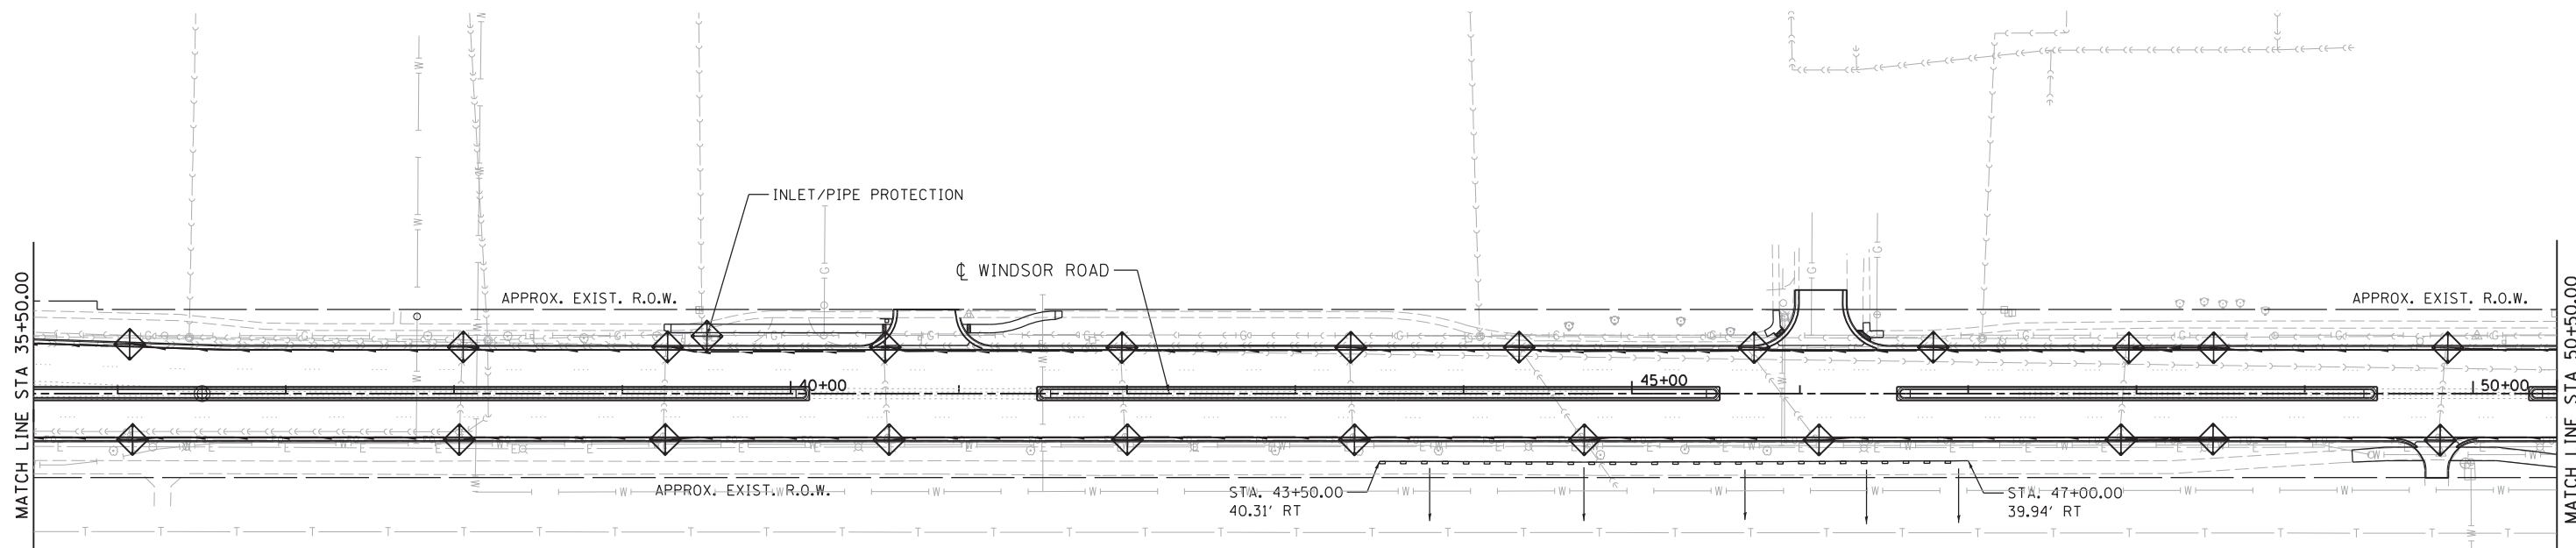

**LEGEND**


- INLET FILTER - SEE SCHEDULES
- PERIMETER EROSION BARRIER
- DRAINAGE PATTERN DIRECTION

- 1.PLACEMENT OF PERIMETER EROSION BARRIER PRIOR TO COMMENCEMENT OF ANY WORK. SEE STANDARD 280001.
- 2.PLACEMENT OF INLET FILTERS AND PIPE PROTECTION PRIOR TO BEGINNING CONSTRUCTION. SEE STANDARD 280001.
- 3.PLACEMENT OF TEMPORARY SEEDING ON GRADED SURFACES NOT HAVING PERMANENT SEEDING APPLIED.
- 4.ONGOING MAINTENANCE OF EROSION CONTROL ELEMENTS PER THE SWPPP.
- 5.REMOVE TEMPORARY EROSION CONTROL ELEMENTS AFTER FINAL GRADING AND PERMANENT SEEDING ESTABLISHED AS PER THE SWPPP AND APPROVED BY THE ENGINEER.

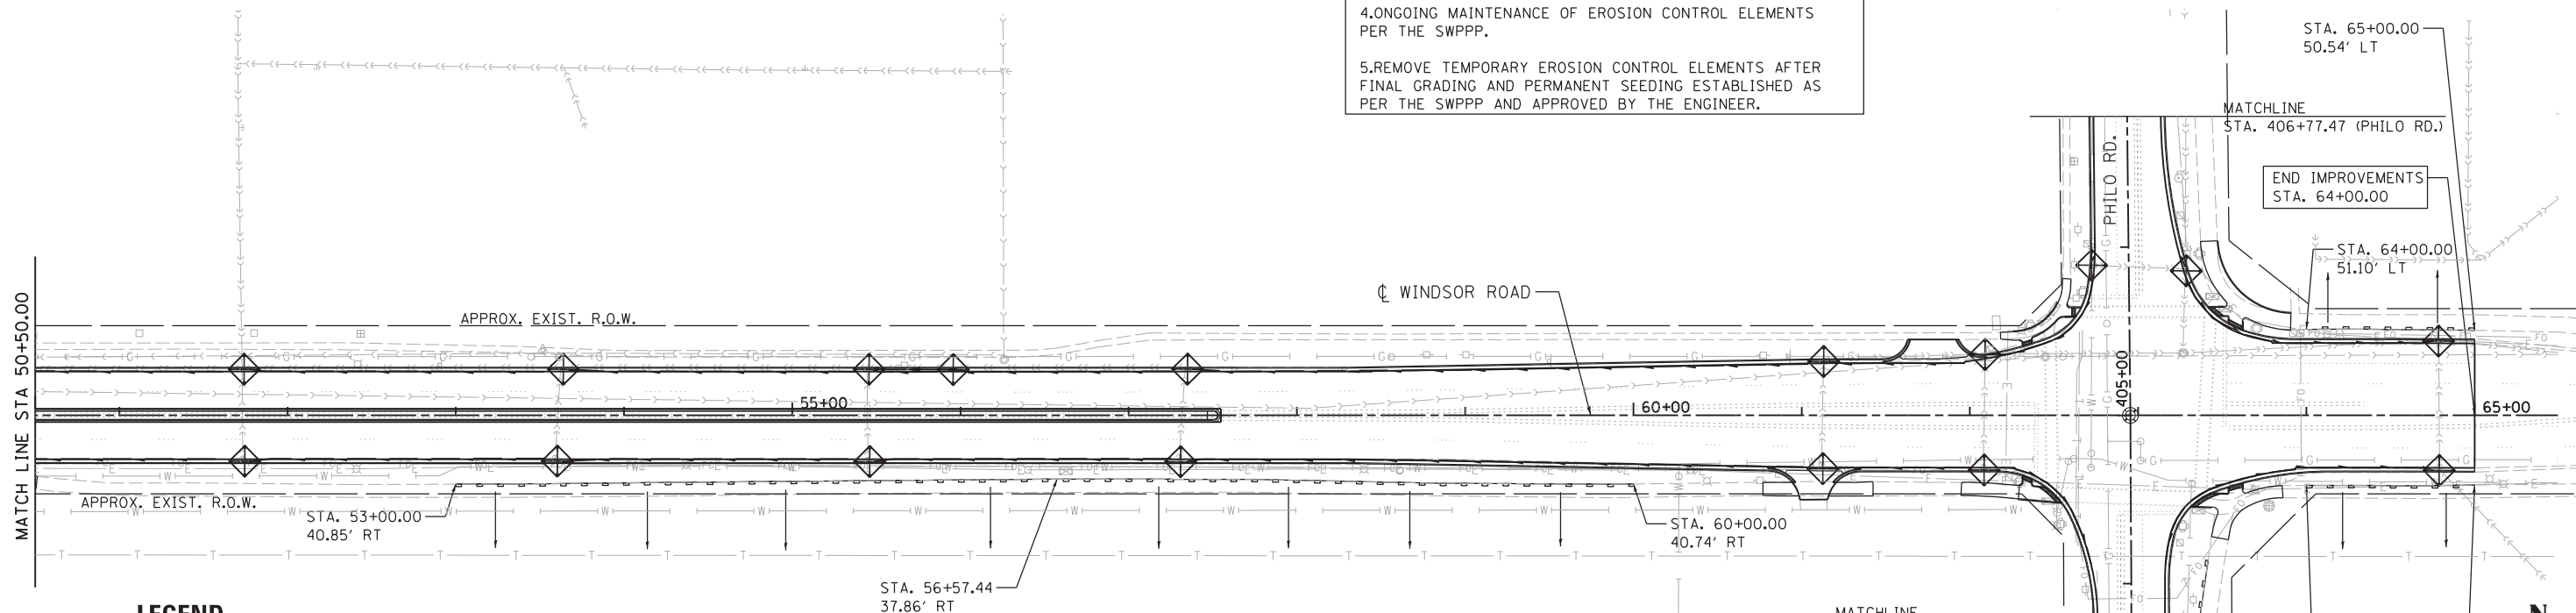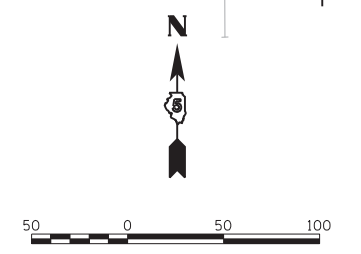

**LEGEND**

- INLET FILTER - SEE SCHEDULES
- PERIMETER EROSION BARRIER
- DRAINAGE PATTERN DIRECTION

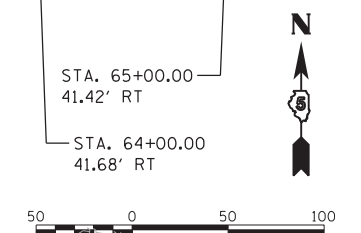

DESIGNED	MH	4/29/14
DRAWN	RSJ	4/29/14
REVIEWED	MH	4/29/14



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MODEL NAME = Erosion Control	PLOT SCALE = 100.0000' / in.	DRAWN - RSJ	REVISED -
PENTABLE NAME = ...	PLOT DATE = 06/12/2014	CHECKED - MH	REVISED -
		DATE - 05-03-2014	REVISED -

**STATE OF ILLINOIS  
DEPARTMENT OF TRANSPORTATION**



**EROSION CONTROL  
WINDSOR ROAD**


SCALE: 1" = 50' SHEET 2 OF 3 SHEETS STA. TO STA.

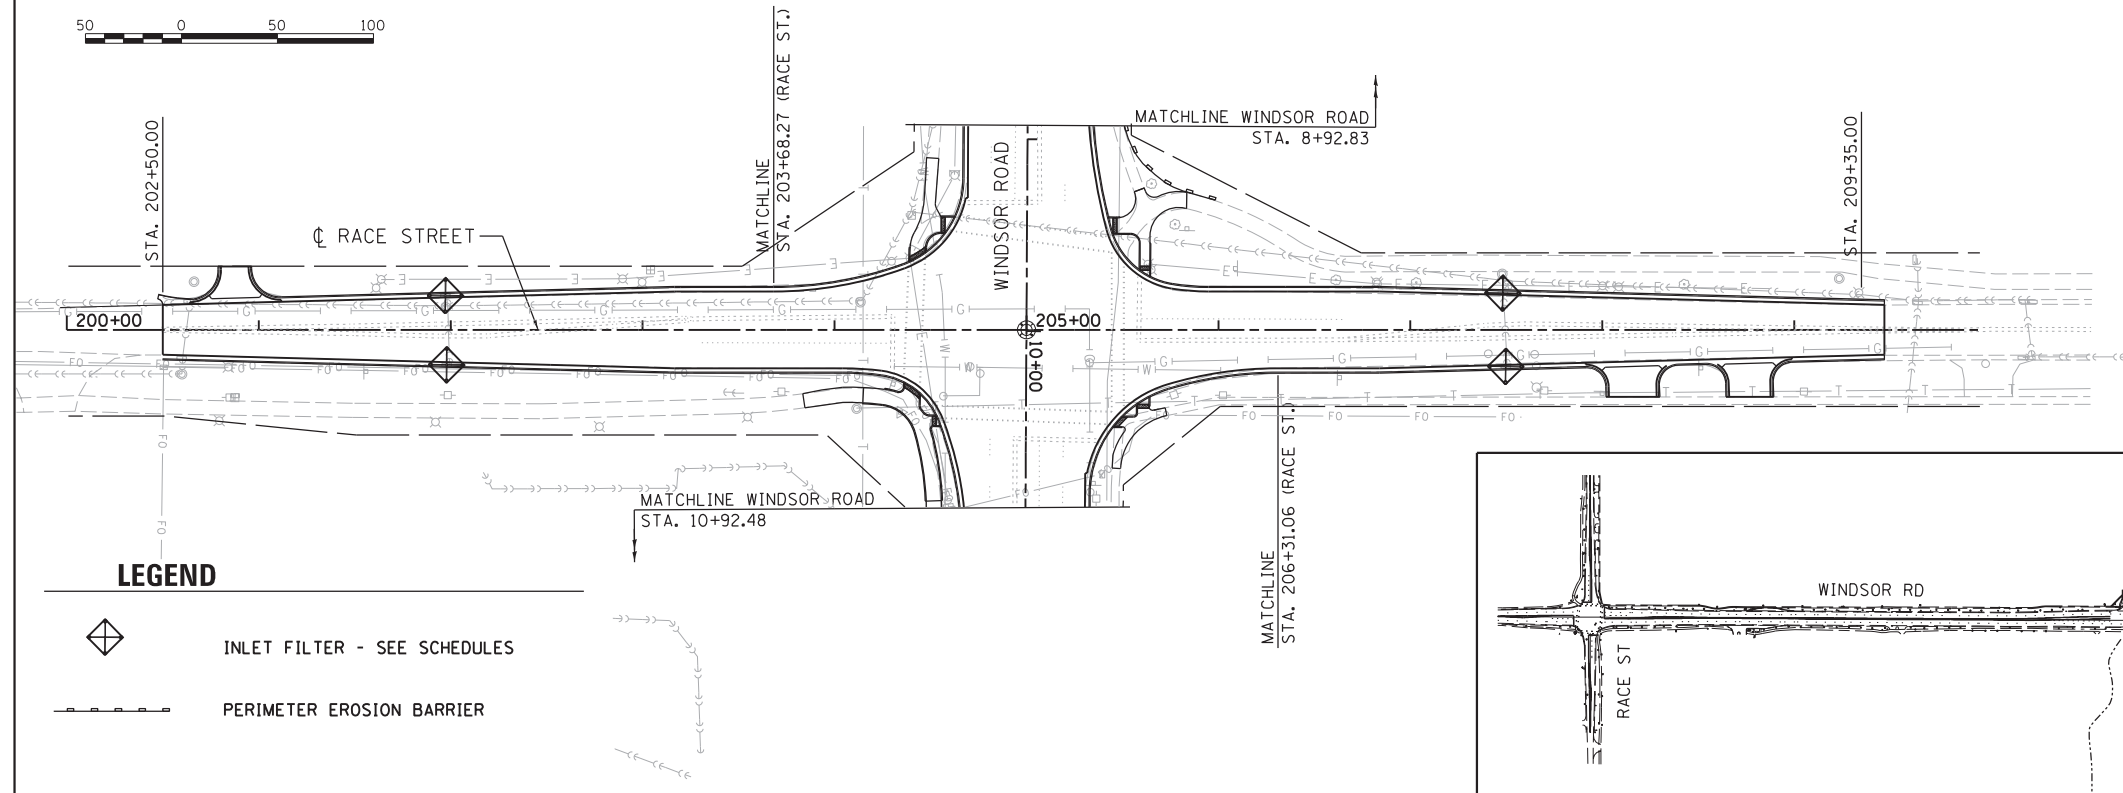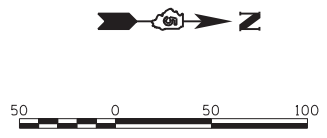F.A. RTE. 7145	SECTION 13-00540-00-PV	COUNTY CHAMPAIGN	TOTAL SHEETS 80	SHEET NO. 35
13L0201		CONTRACT NO. 91515	ILLINOIS FED. AID PROJECT	





**LEGEND**

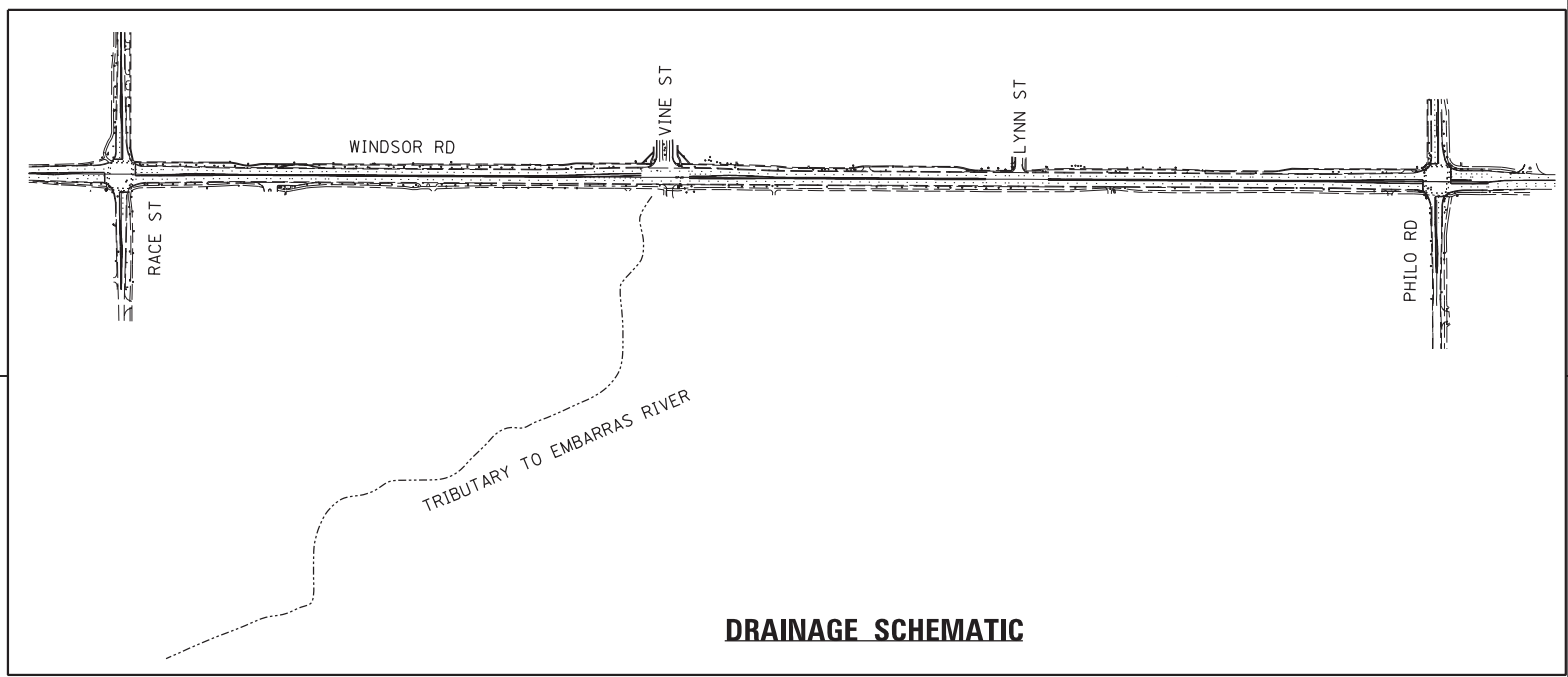

-  INLET FILTER - SEE SCHEDULES
-  PERIMETER EROSION BARRIER

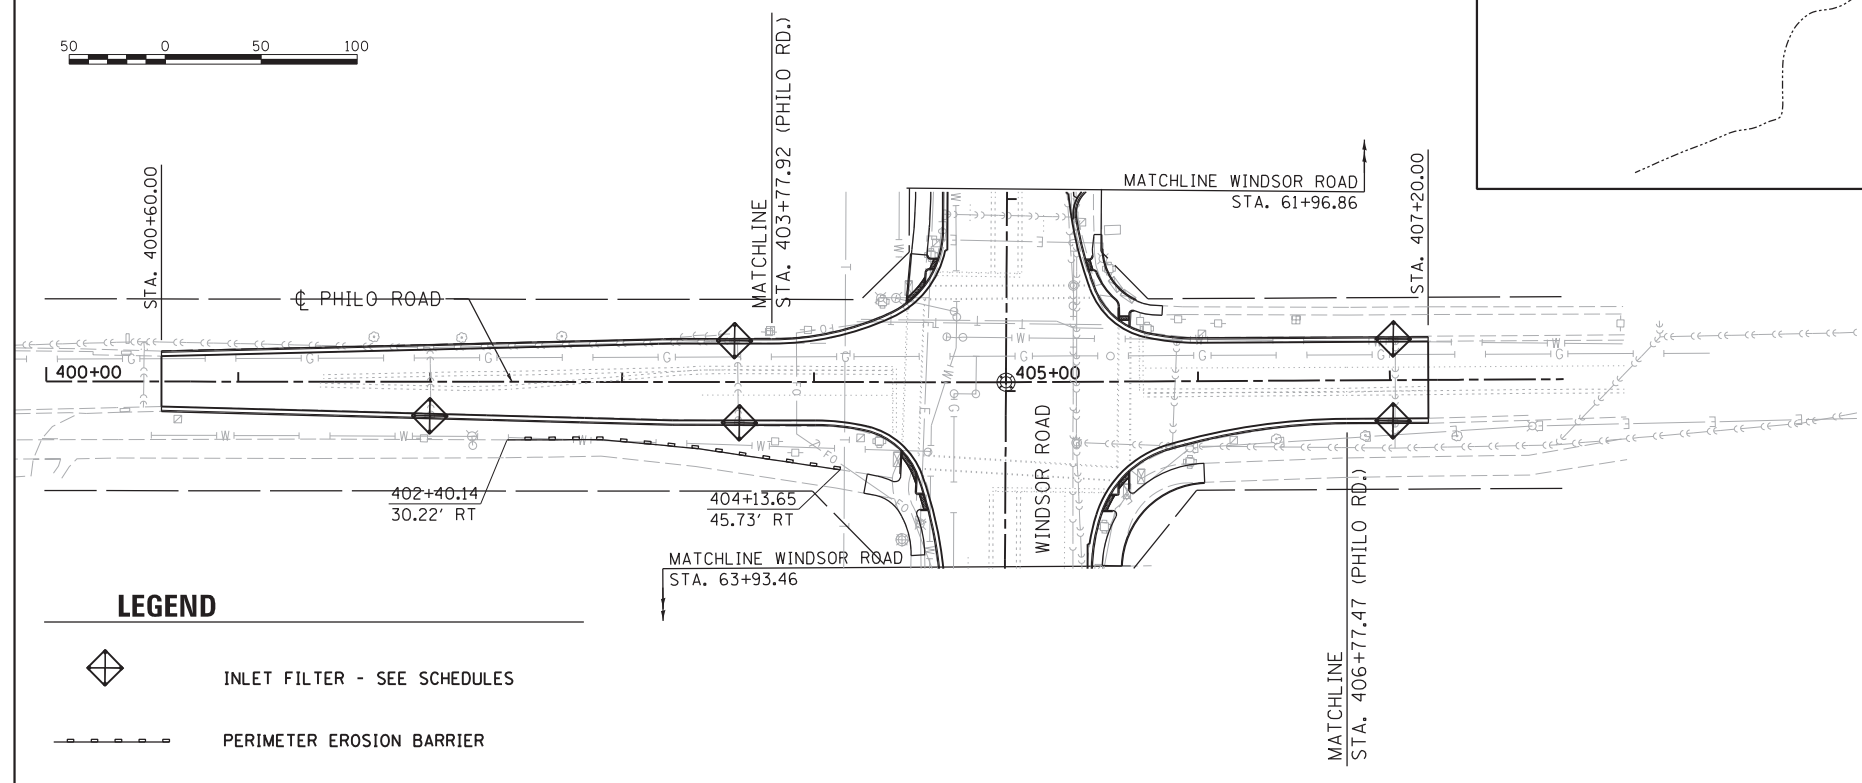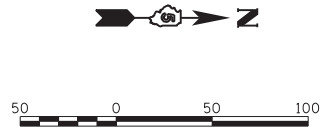

**DRAINAGE SCHEMATIC**



**LEGEND**

-  INLET FILTER - SEE SCHEDULES
-  PERIMETER EROSION BARRIER

DESIGNED	MH	4/29/14
DRAWN	RSJ	4/29/14
REVIEWED	MH	4/29/14

FILE NAME = D513L0201-shr-eros03	USER NAME = johns00944	DESIGNED - MH	REVISED -
MODEL NAME = Erosion Control	PLOT SCALE = 100.0000' / in.	DRAWN - RSJ	REVISED -
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	DATE = 05-03-2014	DATE - 05-03-2014	REVISED -

**STATE OF ILLINOIS  
DEPARTMENT OF TRANSPORTATION**

**EROSION CONTROL  
WINDSOR ROAD**

SCALE: 1" = 50' SHEET 3 OF 3 SHEETS STA. TO STA.

F.A. RTE.	SECTION	COUNTY	TOTAL SHEETS	SHEET NO.
7145	13-00540-00-PV	CHAMPAIGN	80	36
	13L0201	CONTRACT NO.	91515	
ILLINOIS FED. AID PROJECT				